
SD SAMPARE SINCE UNE SD SAMPARE SINCE UNE BD SAMPARE SINCE UNE BD SAMPARE SINCE UNE BD SAMPARE SINCE SAMPARE SINCE SAMPARE SINCE SAMPARE SINCE SAMPARE SINCE SAMPARE SINCE SAMPARE SINCE SAMPARE SINCE SAMPARE SINCE SAMPARE SINCE SINCE SAMPARE SINCE SINCE SAMPARE SINCE SINCE </th <th></th> <th>LEGEND SECTION CORNER SET 1/2"x24" REBAR W/ OLSSON CONT FOUND REBAR FIRE HYDRANT WATER VALVE WATER METER WATER METER WATER MANHOLE GAS METER STORM SEWER MANHOLE SANITARY SEWER MANHOLE SANITARY SEWER MANHOLE SANITARY SEWER CLEANOUT ELECTRIC RISER ELECTRIC RETER ELECTRIC TRANSFORMER ROOF DRAIN GAS LINE WATER LINE</th> <th>TROL CAP</th> <th>974 974</th> <th>Grass Field Spire Gas Line (Per Gas Maps ±) (No Markings) 30' wide Access Esmtt. Doc. No, I-906979 i Bk. I-1905, Pg. 825</th> <th></th>		LEGEND SECTION CORNER SET 1/2"x24" REBAR W/ OLSSON CONT FOUND REBAR FIRE HYDRANT WATER VALVE WATER METER WATER METER WATER MANHOLE GAS METER STORM SEWER MANHOLE SANITARY SEWER MANHOLE SANITARY SEWER MANHOLE SANITARY SEWER CLEANOUT ELECTRIC RISER ELECTRIC RETER ELECTRIC TRANSFORMER ROOF DRAIN GAS LINE WATER LINE	TROL CAP	974 974	Grass Field Spire Gas Line (Per Gas Maps ±) (No Markings) 30' wide Access Esmtt. Doc. No, I-906979 i Bk. I-1905, Pg. 825	
BUNK BENCHMARK CF C HAN UNK FROE CONTOL FONT DETAL PIPE CONTOL POINT CP CONTOL POINT CP CONTOL POINT CP CONTOL POINT CP CONTOL ELEC TRISE ELECTRIC RISER E. PLOW UNCE FF FF FF FF FF FF FF FF FF F	-P-OH- $-FO$ $-SS$ $-SD$ $-SD$ $-FOV$ $-F$	OVERHEAD POWER LINE UNDERGROUND FIBER OPTIC LINE SANITARY SEWER LINE STORM LINE FIBER OPTIC VAULT BRICK SUPPORT COLUMN GRATE INLET SIGN ACCESSIBLE PARKING SIGN POWER POLE LIGHT POLE LIGHT POLE YARD LIGHT AIR CONDITIONER DECIDUOUS TREE BUSH TREE LINE GUY ANCHOR WIRE BUILDING LINE ASPHALT AMERICAN TELEPHONE & TELEGRAPH BOOK	Spire Gas Line		CTL SET 1/2 REBAR (CP-101) ELEV.=970.85' 92.28' 18" OAK G G G G G G G G	Grass RD Grass RD Conc. AC AC AC AC AC AC AC AC AC AC AC AC AC A
(M) MEASURED DIMENSION - THIS SURVEY (P) PLATTED DIMENSION ③ NUMBER OF PARKING STALLS ACCESSIBLE PARKING SPOT ★ DENOTES OA BENCHMARK	BMK CLF CMP CONC. CP CTL ELEV. ELR F F FND HDWL LSA MHR PG. PTP VC R/W RBCP RCP UG	BENCHMARK CHAIN LINK FENCE CORRUGATED METAL PIPE CONCRETE CONTROL POINT CORRUGATED PLASTIC PIPE CONTROL ELEVATION ELECTRIC RISER FLOW LINE FINISH FLOOR ELEVATION FOUND CONCRETE HEADWALL LANDSCAPE AREA METAL HANDRAIL PAGE PEDESTRIAN TRACTION PAD POLYVINYL CHLORIDE PIPE RIGHT-OF-WAY REBAR WITH CAP REINFORCED CONCRETE PIPE UNDERGROUND		(W) (W) (W) (W) (W) (W) (W) (W)	G Fiber Optic e Markings ± Asph. REE 92.99 Grass 18" TREE 0 92.99 Grass 18" TREE 0 92.99 Grass 18" TREE 0 92.99 Movable Dumpster Dumpster Dumpster Dumpster Dumpster	Conc. Walk Grass SCO 13" TRI FH Grat FH Grat Clear P-UG
$G = 888 \cdot 20'54''E = 505 \cdot 06' = 0$	(M) (P) (9)	MEASURED DIMENSION - THIS SURVEY PLATTED DIMENSION NUMBER OF PARKING STALLS ACCESSIBLE PARKING SPOT DENOTES OA BENCHMARK	End of UG F Cable M Found Gas Line Flag 4. North of North edge of F (Believe to be in Err BMK#I FND BMK SP BMK#I FND BMK SP ELEV=976.	стазз Grass	Conc. Curb & Gutter	Asphal Parking

DWG:

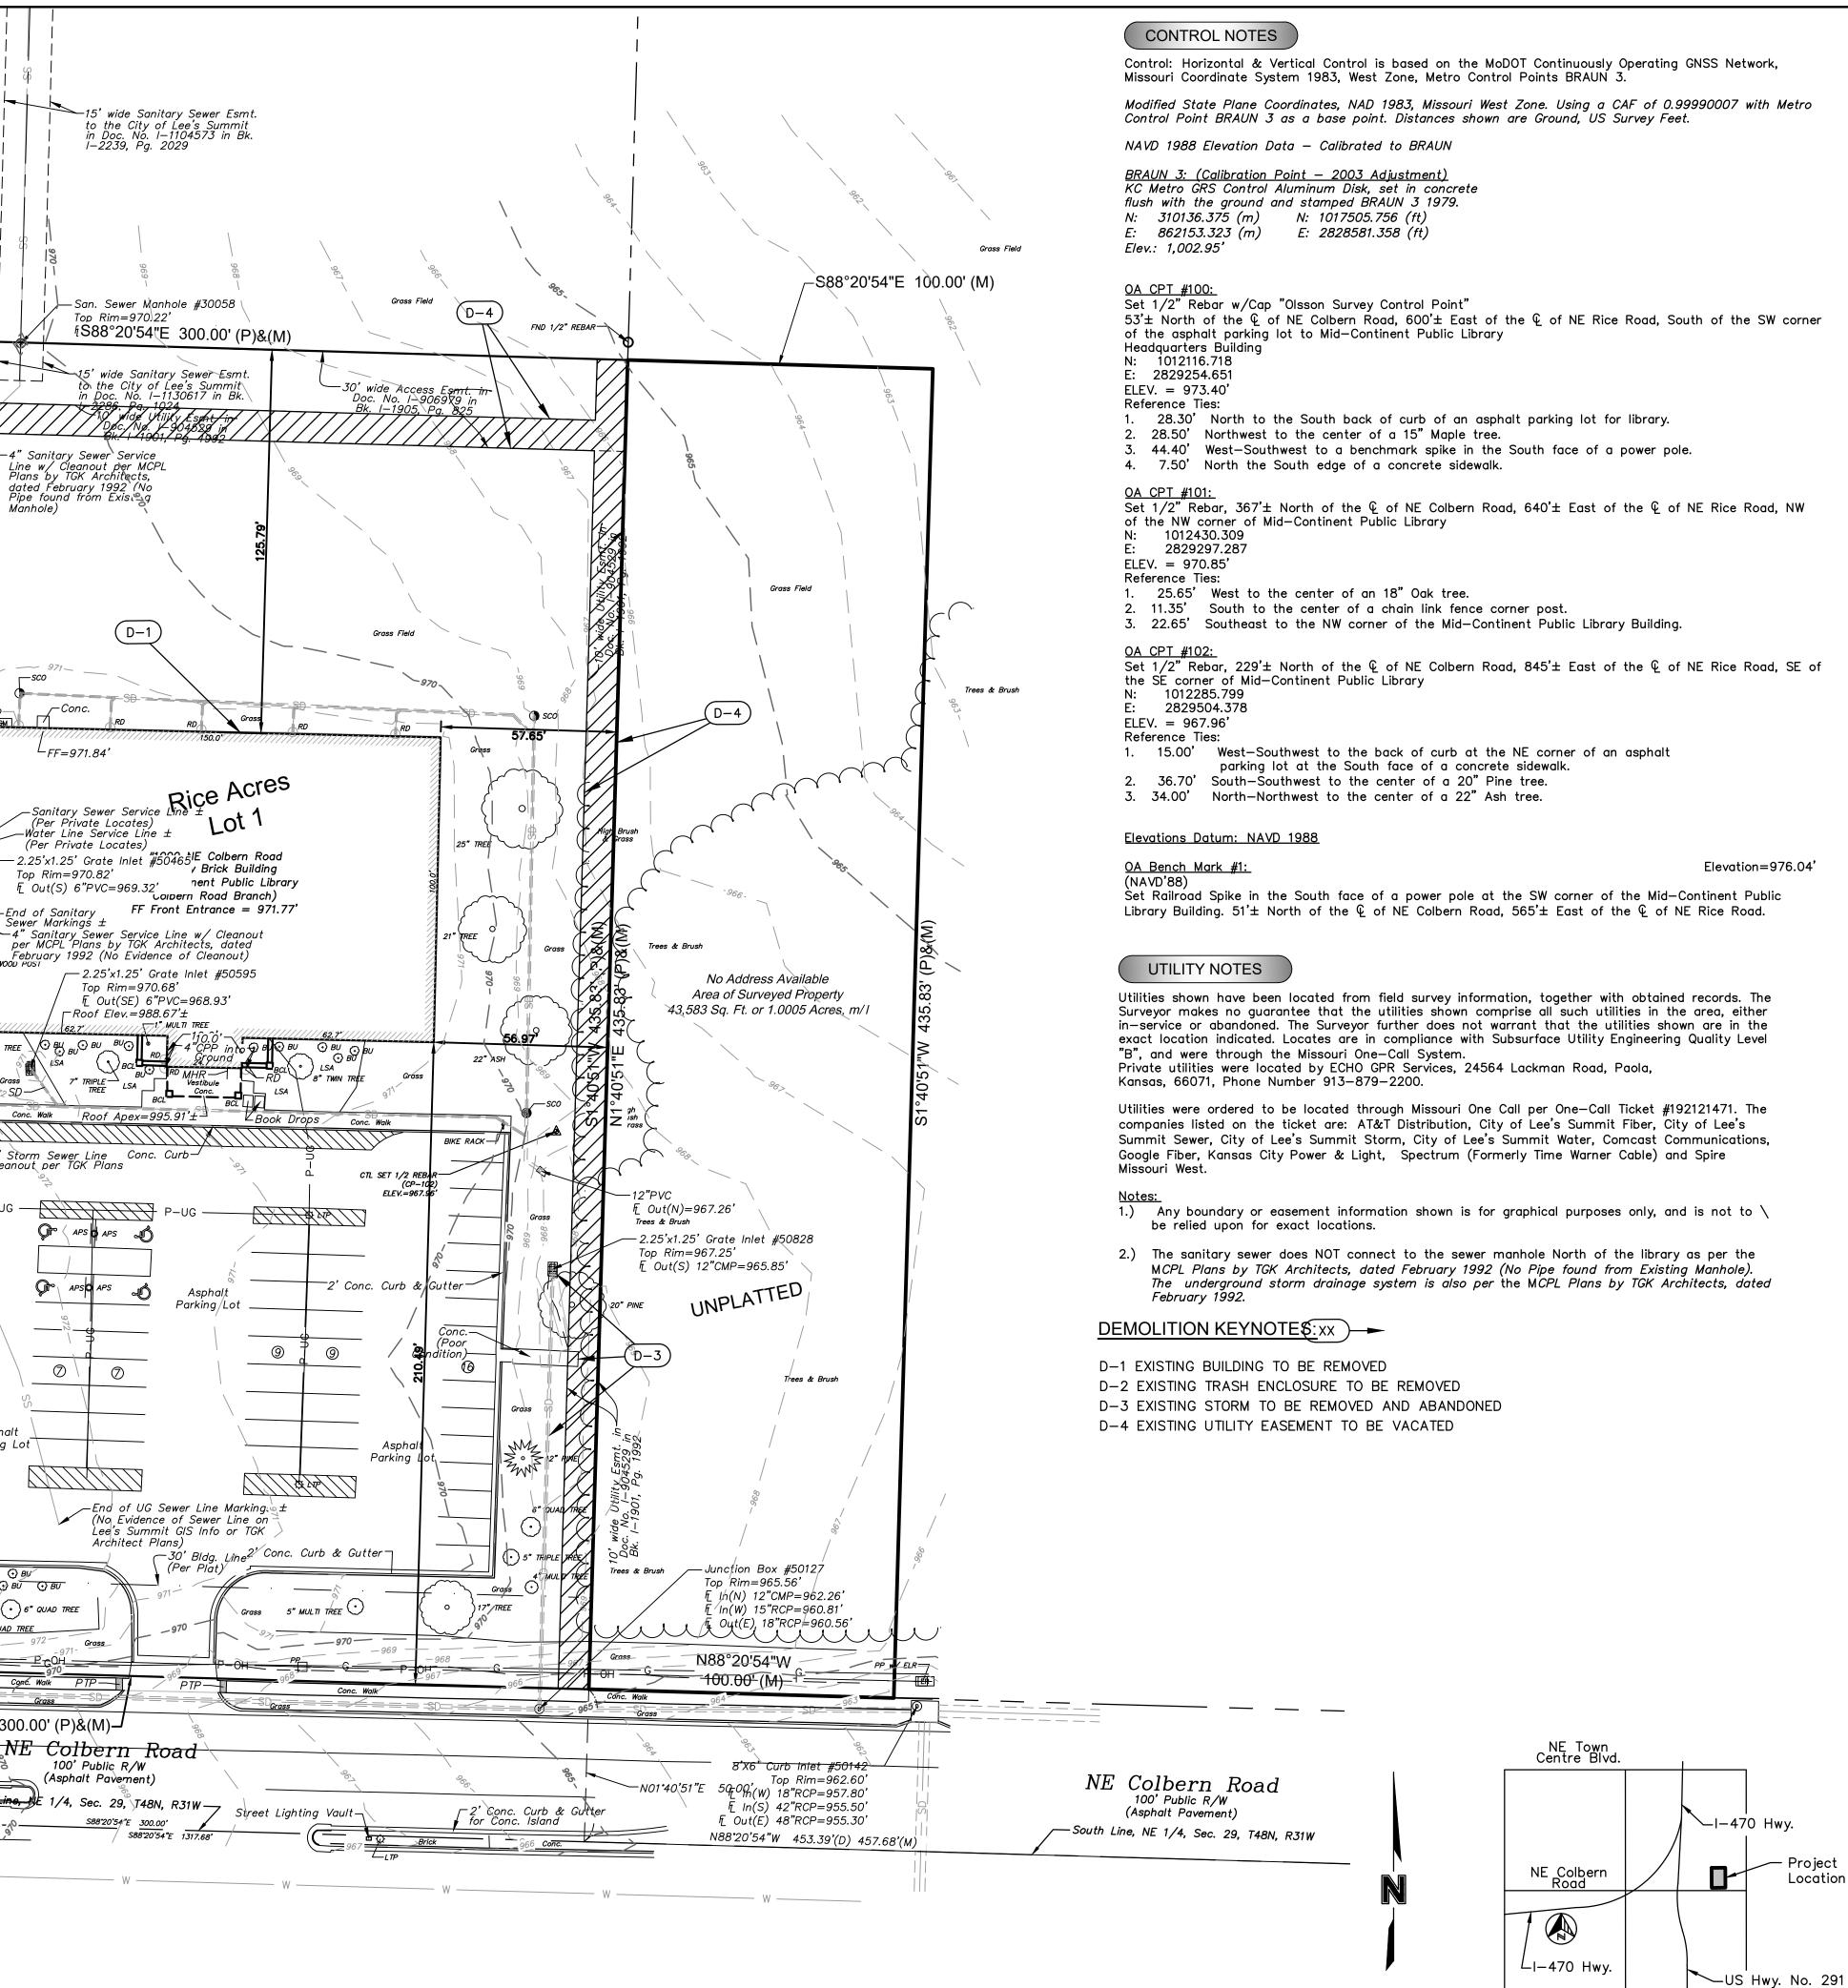

SAPP SAPP SAPP SAPP SAPP SAPP SAPP SAPP SAPP Sapp Design Associates Architects, P.C. Missouri State Certificate of Authority #000607									
helix.									
1629 Walnut Kansas City, MO 64108 816.300.0300									
SPECIAL NOTICES In the event the client consents to, allows, authorizes or approves of changes to any plans, specifications or other construction documents, and these changes are not approved in writing by the design professional, the client recognizes that such changes and the results thereof are not the responsibility of the design professional. Therefore, the client agrees to release the design professional from any liability arising from the construction, use or result of such changes. In addition, the client agrees to the fullest extent permitted by law, to indemnify and hold the design professional harmless from any damage, liability or cost (including reasonable attorney's fees and costs of defense) arising from such changes.									
Mid-Continent Public Library PRELIMINARY DEVELOPMENT PLANS FOR COLBERN ROAD BRANCH 100 N.E. COLBERN ROAD BRANCH 100 N.E. COLBERN ROAD LEE'S SUMMIT, MO 64086 JACKSON COUNTY									
Engineer of Record PRELIMINARY DEVELOPMENT PLAN									
NOT FOR CONSTRUCTION 12.10.19									
Terry M Parsons, Engineer MO PE-2018010505									
Olsson 7301 West 133rd Street, Suite 200 Overland Park, KS 66213 TEL 913.381.1170 FAX 913.381.1174 www.olssonassociates.com Olsson Missouri State Certificate of Authority #001592 Revision No. Description Date									
Revision No.DescriptionDateProject No.DateDrawnB18-033009-18-18KDPDrawing No.Drawing No.Drawing No.									

EXISTING CONDITIONS Copyright 2018 - Sapp Design Associates, Architects, P.C.


Section 29, T48N, R31W

VICINITY MAP

Scale: 1" = 2000'

15' 30'

SCALE IN FEET

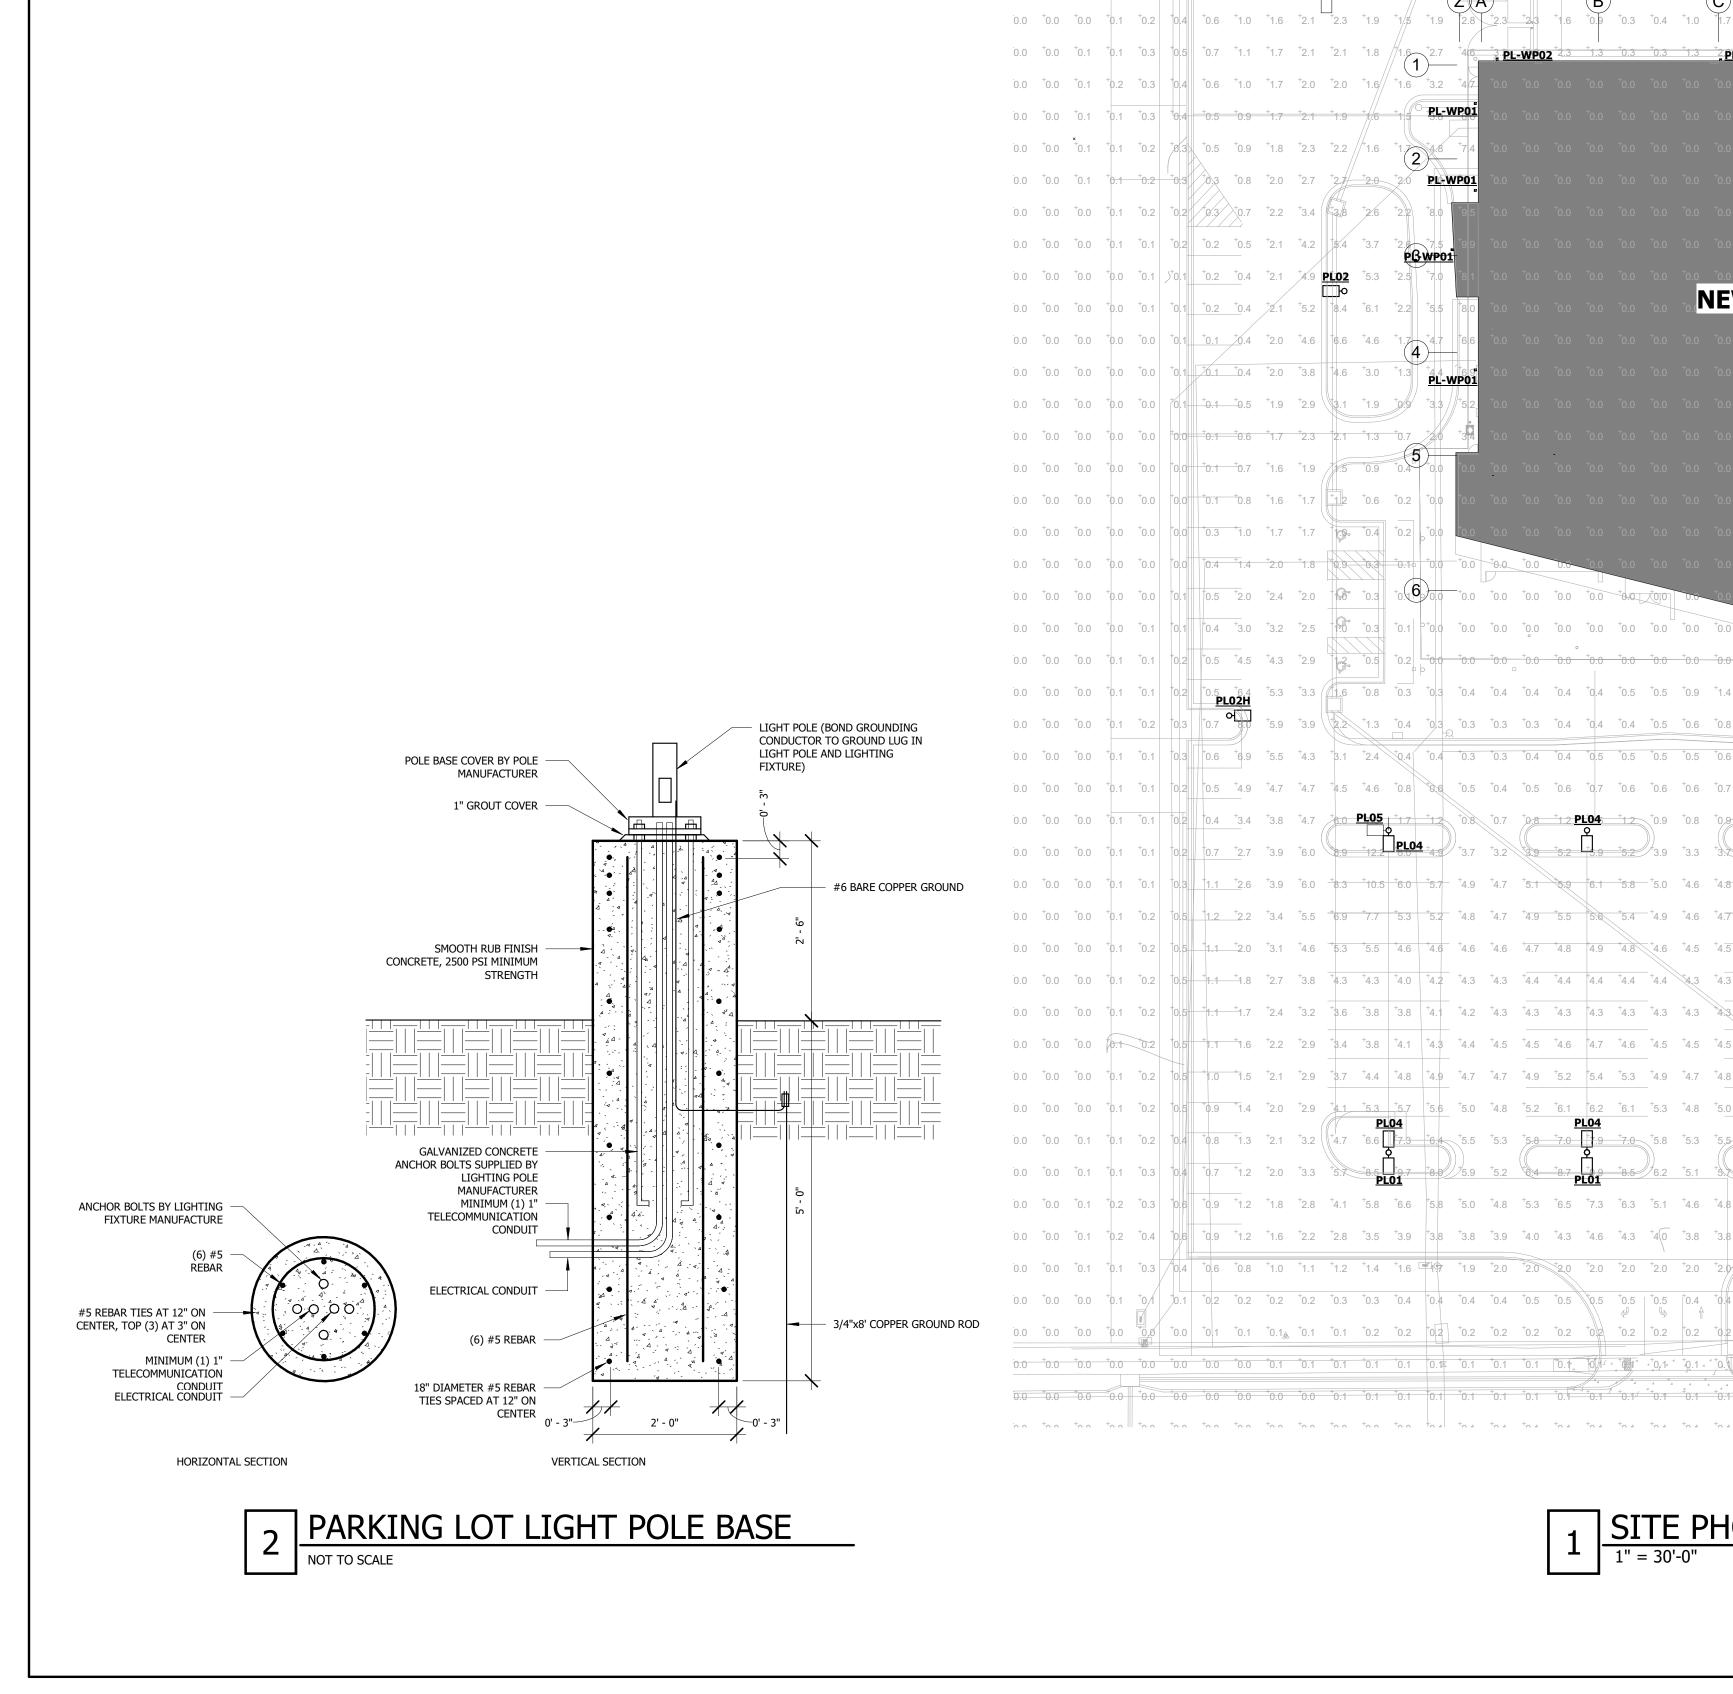

JMB	ER				DR	IVER		FI	NISH		VOLT	AGE	LA	МР ТҮР	PE	LAMP QTY		DLOR EMP	TOT/ WATT/		N	OTES		EQUI\	ALEN	rs
	R-2-UN R-2-UN					STD STD			um gr um gr		UN' UN'			LED LED		.	4	000	122 122	2		1,2 1,2				
	2-UNV- R-3-UN					GTD GTD			um gr um gr		UN UN			LED LED			_	000 000	122 183			1,2 1,2				
AR-2	R-4-UN 2-UNV-1	HIS-MO	GY		Ś	STD STD		MEDI	um gr um gr	AY	UN UN	v		LED LED			4	000 000	183 122	2		1,2 1,2				
509K4		-				STD DIM		BY	UM GR ARCH	AY	UN 120)		LED			4	000	183 56			1,2				
	[FINIS [FINIS	-				-			' ARCH ' ARCH		120 120			LED LED				000 000	47 25			1				
+0.0) ⁺ 0.	0 +0	.0	+0.0	+0.0	+0.0	+0.0	+0.0	+0.0	+0.0	+0.0	+0.0	+0.0	+0.0	+0.0	+0.0	+0.0	+0.0	+0.0	+0.0	+0.0	+0.0	⁺ 0.0	+0.0	+0.0	+0.0
+0.0) +0.	0 +0	.0	+0.0	+0.0	+0.0	+0.0	+0.0	+0.0	+0.0	+0.0	+0.0	+0.0	+0.0	+0.0	+0.0	+0.0	+0.0	+0.0	+0.0	+0.0	+0.0	+0.0	+0.0	+0.0	+0.0
+0.0) +0.	0 ⁺ 0	.0	+0.0	+0.0	+0.0	+0.0	+0.0	+0.0	+0.0	+0.0		+0.0	+0.0	+0.0	+0.0	+0.0	+0.0	+0.0	+0.0	+0.0	+0.0	+0.0	+0.0	+0.0	+0.0
⁺ 0.1	I ⁺ 0.	1 +0	.0	+0.0	+0.0	+0.0	+0.0	+0.1	+0.1	+0.1	+0.1	+0.0	-	+0.0	+0.0	+0.0	+0.0	+0.0	+0.0	+0.0	+0.0	+0.0	⁺ 0.0	+0.0	+0.0	+0.0
+0.4	+ ⁺ 0.	3 +0	.2 ([+0.1	+0.1	+0.2	(F)	+0.4	+0.5	+0.3	+0.2 (G	+0.1	+0.1	+0.1	+0.0	+0.0	+0.0	+0.0	+0.0	+0.0	0.0	+0.0	+0.0	+0.0	+0.0
+2.2	2 +1.1	9 ⁺ 1	\sim	+0.4	⁺ Q.1∡	¢.1	+0,5	+1.4	+2.2	⁺ 2.3	⁺ 1.7	+1.0	/	⁺ 0.4	⁺ 0.2	+0.0	+0.0	+0.0	+0.0	+0.0	+0.0	0.0	+0.0	+0.0	+0.0	+0.0
N P	<u>02</u> ⁺ 2.	6 1	.8	+ 4	<u>; 4</u> 0.14	^+_^_ 1	<u>PE</u>	<u>WP02</u>	+2.8	+	+2.0	+	+2.2	⁺ 1.3	+0.3	+0.1	+0.0	+0.0	+0.0	+0.0	+0.0	+0.0	+0.0	+0.0	+0.0	+0.0
													+4.0	⁺ 2.5	+0.4	+0.1	+ 0.0	+0.0	+0.0	+0.0	+0.0	0.0	+0.0	+0.0	+0.0	+0.0
													⁺ 6.3	⁺ 3.7	+0.6	+0.1	+0.0	+0.0	+ 0.0	+0.0	+0.0	0.0	+0.0	+0.0	+0.0	+0.0
													⁺ 6.0	⁺ 3.5	⁺ 0.5	+0.1	+0.0	+0.0	+0.0	+0.0	+0.0	+0.0	+0.0	+0.0	+0.0	+0.0
													+4.2	+2.0	⁺ 0.4	+0.1	+0.0	+0.0	+0.0	+0.0	+0.0	+0.0	+0.0	⁺ 0.0	+0.0	+0.0
													7 +1.9	⁺ 1.3	⁺ 0.4	+0.1	+ 0.0	+0.0	+0.0	+0.0	⁺ 0.0	0.0	+0.0	+0.0	+0.0	⁺ 0.0
												⁺ 0.0	PL-W 2.2	P01 1.7	+0.4	+0.1	+0.0	+0.0	+0.0	+0.0	+0.0	0.0	+0.0	+0.0	+0.0	+0.0
+0.0																			+ 0.0	+0.0	+0.0	0.0	+0.0	+0.0	+0.0	+0.0
	Βl													+4.0					+ 0.0		+ 0.0		/ +0.0	+0.0		+0.0
														+3.8					+0.0	+0.0	+0.0	+0.0	+0.0	+0.0	+0.0	+0.0
												ſ									+0.0	+0.0	⁺ 0.0	+0.0	+0.0	+0.0
																				_		0.0	+0.0			+0.0
																	/				+0.0		+0.0			+0.0
																			+0.0		+0.0	+0.0				+0.0
																								+0.0		+0.0
												r		/			//	/						0.0 ⁺		+0.0
																								0.0 ⁺		+0.0
																		+0.1								
) +0.			r		<u>PL-</u>	0.0 5G01			G01	0.0			+2.3		/			+0.2		+0.1			+0.1		
)							⁺ 3.5													+0.2			+0.1		
+0.6) + 0.: □	0 ⁺ 0						+4.0_0						<u> </u>	_									+0.2		+0.1
+1.6	6 ⁺ 1.	8 ⁺ 1	.9	+1.9	⁺ 2.7	4.0	4.5	3.9	4.3	5.8	4.9	3.7	3.0	2.7	2.4	2.4	2.9	2.8	⁺ 2.2	+1.4	+0.9	0.7	+0.5	+0.3	⁺ 0.2	+0.1
+1.0) ⁺ 1.	2 ⁺ 1.	.3	⁺ 1.6	+2.0	+2.7	G 3 3	+3.7	5,3.9	+ 4.2	4.26	\$ 3.9	*3.6	+3.4	+3.2	+3.4	+4.3	⁺ 3.9	+2.9	1.5	+1.0	0.7	+0.6	+0.4	+0.2	+0.1
+0.9) ⁺ 1.	1 1	.2	⁺ 1.4	⁺ 1.7	+2.3	⁺ 3.1	⁺ 3.9	⁺ 4.5	+4.7	+4.6	⁺ 4.2	⁺ 4.1	+4.3	+4.4	4.9	⁺ 6.3	⁺ 5.2	+3.3	1.6	+1.0	*0.8	+0.6	+0.4	+0.2	+0.1
+0.9) ⁺ 1.:	2 1	.3	⁺ 1.4	⁺ 1.7	⁺ 2.3	⁺ 3.3	+4.7	⁺ 5.8 <u>PLC</u>	+6.0 <u>3</u>	⁺ 5.5	⁺ 4.8	+4.6	+5.2	+5.9	+6.9 <u>-03</u>	⁺ 9.2	⁺ 6.7	⁺ 3.5	+1.7	+1.0	*0.7	+0.5	+0.4	⁺ 0.2	+0.1
+1.3	<u>PL</u> کم	04 ⁽ 2	.8	+1.6	+47	+2.2	+3.3	4.9	6_3 ¢	+6.5	+5.7	+4.6	⁺ 4.5	+5.4	/6.5	<u>PL0</u> 오	<u>5+11.5</u>	+7.3	⁺ 3.5	+1.6	+0.9	+0.6	+0.4	+0.3	+0.2	⁺ 0.1
+4.9		9 +5	.6	+4.4	3.3	⁺ 3.1	+3.9	+5.4	+ ₇ PLC	+ <u>7.3</u>	+61	⁺ 5.1	⁺ 5.0	6.0	+ _{7.5} <u>Pl</u>	<u>-04</u>	+12,5	7.6	⁺ 3.7	+1.7	+0.9	+ *0.5	⁺ 0.3	+0.2	+0.1	⁺ 0.1
+ 5.5	5 ⁺ 6.	0 5	.8	+4.9	4.2	⁺ 4.1	⁺ 4.5	+ <u>5.5</u>	+6.7	+6.9	+6.1	⁺ 5.3	⁺ 5.2	+5.8	+6.7	+7.5	+10.2	+6.9	⁺ 3.7	+1.9	+1.1	*0.6	+0.3	+0.1	+0.1	+0.0
⁺ 5.1	5.	3 5	.2	4.7	4.3	⁺ 4.2	+4.4	+5.1	+5.7	⁺ 5.9	+5.5	⁺ 5.1	⁺ 5.0	+ 6.3	⁺ 5.6	+6.2	+7.6	⁺ 5.8	⁺ 3.6	+1.9	+1.2	*0.7	⁺ 0.3	+0.1	+0.1	+0.0
+4.6	3 4.	6 [†] <u>4</u>	.5	4.3	4.2	⁺ 4.2	4.3	4.5	4.8	4.9	4.9	⁺ 4.8	+4.7	4.7	4.7	4.8	+5.5	4.7	⁺ 3.4	+1.9	+1.3	*0.8	+0.4	+0.1	+0.1	+0.0
+4.3	3 4.	1 3	.9ª	⁺ 4.0	⁺ 4.1	⁺ 4.1	⁺ 4.1	⁺ 4.1	+4.1	+4.3	+4.5	⁺ 4.5	+4.4	4.4	4.1 (+3.9	⁺ 4.2	+3.9	⁺ 3.1	+2.0	+1.4	+0.8	+0.4	+0.1	+0.1	+0.0
+4.2	2 +4.	0 +3,	.8 ⁴	⁺ 3.9	+4.0	⁺ 4.1	⁺ 4.1	+4.0	+4.0	+4.2	+4.4	+4.4	+4/3	⁺ 4.3	+4.0	+3.7	⁺ 3.6	+3.3	⁺ 2.8	⁺ 1.9	+1.4	*0.8	+0.3	+0.1	⁺ 0.1	+0.0
+4.4	4.	3	.2	⁺ 4.1	⁺ 4.1	+4.2	+4.2	⁺ 4.2	+4.4	⁺ 4.5	+4.6	+4.6	4.5	⁺ 4.5	⁺ 4.3	+4.0	⁺ 3.6	⁺ 3.2	⁺ 2.6	⁺ 1.9	+1.3	*0.8	+0.4	+0.1	⁺ 0.1	+0.0
⁺ 5.0) [†] 5.	1 4	.9	⁺ 4.6	+4.3	⁺ 4.2	+4.4	+4.8	⁺ 5.1	⁺ 5.3	+5.1	⁺ 4.9	+4.8	+4.9	⁺ 5.0	+4.7	⁺ 4.1	+3.3	+2.5	⁺ 1.8	+1.2	+0.7	⁺ 0.3	+0.1	+0.1	+0.0
⁺ 5.7			.8	⁺ 5.0	+4.4	+4.2	⁺ 4.5	+5.3	+6.0	+6.2	+5.8	⁺ 5.1	+4.9	⁺ 5.4	⁺ 5.9	+5.6	⁺ 4.8	+3.5	⁺ 2.4	+ <u>1.7</u>	+1.1	0.6	⁺ 0.3	+0.1	⁺ 0.1	+0.0
+6.5	<u>PL</u> 5+7		, .1	+5.6	+4.6	⁺ 4.3	+4.7	+5.8	+7.4		+6.4	⁺ 5.5	⁺ 5.4	+5.9		<u>.04</u> + _{7.4}	+5.7	+4.0	⁺ 2.6	+1.6-	+1.0	+0.6	+0.3	+0.1	⁺ 0.1	+0.1
+7.6	¢ ↓ ₽Ľ		2	+6.7	+	+4.0	+4.6	+6.4	¢ 	+ <u>9.0</u>	+	⁺ 5.4	⁺ 5.1	6.5	+ _{8.7}	¥ <u>1</u> +9.2 ∩1	+7.0)) +4.3	⁺ 2.5	+1.5	+1.0	0.6	+0.4	+0.2	⁺ 0.1	+0.1
+5.7			.6	⁺ 5.3	⁺ 4.3	+4.0	⁺ 4.3	⁺ 5.3	+6.6	<u>11</u> +6.8	⁺ 5.7	⁺ 4.9	+4.7	⁺ 5.2	+6.2	+6.4	⁺ 5.0	⁺ 3.5	⁺ 2.3	+1.6	+1.1	0.8	+0.5	+0.3	+0.1	⁺ 0.1
+3.9		3 4	.2	⁺ 3.8	⁺ 3.5	⁺ 3.4	⁺ 3.6	⁺ 3.8	⁺ 4.2	⁺ 4.3	+4.0	⁺ 3.8	⁺ 3.8	⁺ 3.7	⁺ 3.8	⁺ 3.7	⁺ 3.1	⁺ 2.5	⁺ 1.9	+1.4	+1.1		+0.5	+0.3	+0.1	⁺ 0.1
1.9			7) 8/	+1.8	+1.9	+2.0	+1.9	+1.8	+1.9	+1.8	+1.8	+1.9	+1.9	+1.8	+1.6	+1.4	+1.3	+1.1	+1.0	+0.9	+0.7	0.5	+0.3	+0.2	+0.1	+0.1
+0.5		d	.5/	+0.4	+0.5	+0.4	+0.5	+0.4	+0.5	+0.5	+0.5	+0.4	+0.4	+0.4	+0.4	+0.4	+0.3	+0.3	+0.2	+0.2	+0.2	0.1	+0.1	+0.1	+0.1	+0.0
																								0.1 - +0.0		
		1																								
											۲												4	+0.0		
J.	0.	1 0	.1	0.1	0.1	0.1	0.1	0.1	0.1	0.1	0.1	0.1	0.1	0.1	0.1	0.1	0.1	0.1	0.0	0.0	0.0	0.0	0.0	+0.0	0.0	0.0

	NOTES: 1.	FIXTURE SHALL B	RATED FOR OUTDOOR USE.						
	2. TYPE	PROVIDE 20' SQU	ARE POLE.	DRIVER	FINISH	VOLTAGE	LAMP TYPE	LAMP	
	PL01 PL02	SIGNIFY	ECF-S-32L-1.2A-NW-G2-AR-2-UNV-MGY ECF-S-48L-1.2A-NW-G2-AR-2-UNV-MGY	STD STD	MEDIUM GRAY MEDIUM GRAY		LED LED	QTY	ļ-
	PL02 PL02H PL03	SIGNIFY SIGNIFY	ECF-S-48L-1.2A-NW-G2-AR-2-UNV-MG1 ECF-S-48L-1.2A-NW-G2-AR-2-UNV-HIS-MGY ECF-S-48L-1.2A-NW-G2-AR-3-UNV-MGY	STD STD STD	MEDIUM GRAY MEDIUM GRAY MEDIUM GRAY	UNV	LED		╞
	PL04 PL04aH	SIGNIFY	ECF-S-48L-1.2A-NW-GR-AR-4-UNV-MGY ECF-S-32L-1.2A-NW-G2-AR-2-UNV-HIS-MGY	STD STD STD	MEDIUM GRAY MEDIUM GRAY	UNV UNV	LED		F
	PL05 PL-SG01	SIGNIFY BEGA	ECF-S-32L-1.2A-NW-G2-AR-5-UNV-MGY BEGA-24509K4	STD DIM	MEDIUM GRAY BY ARCH	UNV 120	LED LED		
	PL-WP01 PL-WP02	EATON EATON	ENC-E02-LED-E1-BL2-[FINISH] ENC-E01-LED-E1-BL2-[FINISH]	-	BY ARCH BY ARCH	120 120	LED LED		
⁺ 0.0	+0.0 ⁺ 0.0	⁺ 0.0 ⁺ 0.0 ⁺ 0.0	+0.0 +0.0 +0.0 +0.0 +0.0 +0.0 +0.0 +0.0	0.0 +0.0 +0.0 +0.0	⁺ 0.0 ⁺ 0.0 ⁺ 0.0	+0.0 +0.0	+0.0 +0.0 +0.0	+0.0 +(0.0
+0.0 +0.0 +0.0 +0.0 +0.0 +0.0 +0.0 +0.0	+0.0 +0.0	+0.0 +0.0 +0.0	+0.0 +0.0 +0.0 +0.0 +0.0 +0.0 +0.0 +0.0	0.0 +0.0 +0.0 +0.0	⁺ 0.0 ⁺ 0.0 ⁺ 0.0	+0.0 +0.0	⁺ 0.0 ⁺ 0.0 ⁺ 0.0	+0.0 +(0.0
⁺ 0.0 ⁺ 0.0 ⁺ 0.0 ⁺ 0.0 ⁺ 0.1 ⁺ 0.1 ⁺ 0.1 ⁺ 0.1 ⁺ 0.1 ⁺ 0.1 ⁺ 0.0	+0.0 +0.0	⁺ 0.0 ⁺ 0.0 ⁺ 0.0	+0.0 +0.0 +0.0 +0.0 +0.0 +0.0 +0.0 +0.0	0.0 +0.0 +0.0 +0.0	+0.0 +0.0 +0.0	+0.0 +0.0	+0.0 +0.0 +0.0	+0.0+	0.0
⁺ 0.0 ⁺ 0.0 ⁺ 0.0 ⁺ 0.1 ⁺ 0.1 ⁺ 0.1 ⁺ 0.2 ⁺ 0.2 ⁺ 0.1 ⁺ 0.1	+0.1 +0.1	⁺ 0.1 ⁺ 0.1 ⁺ 0.1	⁺ 0.0 ⁺ 0.0 ⁺ 0.1 ⁺ 0.1 ⁺ 0.1 ⁺ 0.1 ⁺ 0.0 ⁺ 0	0.0 +0.0 +0.0 +0.0	⁺ 0.1 ⁺ 0.1 ⁺ 0.1	+0.1 +0.0	+0.0 +0.0 +0.0	+0.0 +(0.0
⁺ 0.0 ⁺ 0.0 ⁺ 0.1 ⁺ 0.2 ⁺ 0.3 ⁺ 0.3 ⁺ 0.3 ⁻ 0 ⁺ PLO4aH ^a ⁺ 0.3 ⁺ 0.6	ZA	+0.4 +0.3 +0.2 B)	⁺ 0.3 ⁺ 0.4 ⁺ 0.5 (F)	+0.3 +0.2 (G	+0.1 +0.1 +0.1	+0.0 +(0.0
⁺ 0.1 ⁺ 0.2 ⁺ 0.4 ⁺ 0.6 ⁺ 1.0 ⁺ 1.6 ⁺ 2.1 ⁺ 2.3 ⁺ 1.9 ⁺ 1.5 ⁺ 1.9	⁺ 2.8 ⁺ 2.3	<u>+2</u> ,3 +1.6 +0.9	+0.3 +0.4 +1.0 +1.7 +2.2 +1.9 +1.2 +0	0.4 ⁺ Q.1 ['] ⁺ 0.1 ⁺ 0.5,	*1.4 *2.2 *2.3	⁺ 1.7 ⁺ 1.0	⁺ 0.6 ⁺ 0.4 ⁺ 0.2		0.0
$\begin{array}{c ccccccccccccccccccccccccccccccccccc$	+416 <u>+3</u> .Pl	<u>WP02</u> ^{+2.3} +1.3	<u>+0.3</u> +0.3 +1.3 +2 <u>pL-WpO2</u> +2.6 +1.8 +0).4 0.1 PL-	WP02 ⁺ 2.8 ⁺ 2.7	2.0 1.1			
+0.2 +0.3 +0.4 +0.6 +1.0 +1.7 +2.0 +2.0 +1.6 +1.6 +3.2	u u						⁺ 4.0 ⁺ 2.5 ⁺ 0.4		0.0
+0.1 +0.3 +0.4 +0.5 +0.9 +1.7 +2.1 +1.9 +/6 +1 5 -3.6 +1.5 -3.6 +1.5 -3.6 +1.5 -3.6 +1.5 -3.6 +1.5 -3.6 +1.5 -3.6 +1.5 -3.6 +1.5 +1.5 +1.5 +1.5 +1.5 +1.5 +1.5 +1.5							⁺ 6.3 ⁺ 3.7 ⁺ 0.6		
$^{+}0.1$ $^{+}0.2$ $^{+}0.3$ $^{+}0.5$ $^{+}0.9$ $^{+}1.8$ $^{+}2.3$ $^{+}2.2$ $/^{+}1.6$ $^{+}1.7$ $^{+}1.8$	-						⁺ 6.0 ⁺ 3.5 ⁺ 0.5		
$\begin{array}{c} \begin{array}{c} \begin{array}{c} \begin{array}{c} \begin{array}{c} \begin{array}{c} \\ \end{array} \\ \end{array} \\ \end{array} \\ \begin{array}{c} \end{array} \\ \end{array} \\ \begin{array}{c} \end{array} \\ \end{array} \\ \begin{array}{c} \end{array} \\ \end{array} \\ \end{array} \\ \begin{array}{c} \end{array} \\ \end{array} \\ \end{array} \\ \end{array} \\ \begin{array}{c} \end{array} \\ \end{array} \\ \end{array} \\ \end{array} \\ \begin{array}{c} \end{array} \\ \end{array} \\ \end{array} \\ \end{array} \\ \end{array} \\ \end{array} \\ \begin{array}{c} \end{array} \\ \end{array} $	E					-	7		
$\begin{array}{cccccccccccccccccccccccccccccccccccc$						0			
+0.0 +0.1 50.1 +0.2 +0.4 +2.1 +4.9 PL02 +5.3 +2.5 +7.0							⁺ 4.1 ⁺ 2.7 ⁺ 0.5		
$^{+}0.0$ $^{+}0.1$ $^{+}0.1$ $^{+}0.2$ $^{+}0.4$ $^{+}2.1$ $^{+}5.2$ $^{+}8.4$ $^{+}6.1$ $^{+}2.2$ $^{+}5.5$)			
+0.0 +0.0 +0.1 +0.1 +0.4 +2.0 +4.6 +6.6 +4.6 +1.7 +4.7	1 A A A A A A A A A A A A A A A A A A A								
+00 $+00$ $+01$									
$^{+}0.0$ $^{+}0.0$ $^{+}0.1$ $^{+}0.1$ $^{+}0.5$ $^{+}1.9$ $^{+}2.9$ $^{+}3.1$ $^{+}1.9$ $^{+}9.9$ $^{+}3.3$						+0.0 +0.0	⁺ 1.5 ⁺ 1.1 ⁺ 0.3	+0.1 +	0.0
+0.0 +0.0 +0.1 +0.6 +1.7 +2.3 +2.1 +1.3 +0.7 +2.0	+ 01 314 +0.0					+0.0 +0.0	⁺ 0.6 ⁺ 0.6 ⁺ 0.3	+0.1 +	0.0
+0.0 +0.0 +0.0 +0.1 +0.7 +1.6 +1.9 +5 +0.9 +0.4 +0.0	+0.0 +0.0	• *0.0 [*] 0.0 [*] 0.0				+0.0 +0.0	⁺ 1.8 ⁺ 1.0 ⁺ 0.3	+0.1 +	0.1
+0.0 +0.0 +0.0 +0.1 +0.8 +1.6 +1.7 +1.2 +0.6 +0.2 +0.0						⁺ 0.0 ⁺ 0.0	+4.6 +2.1 +0.5	+0.1 +,	0.1
+0.0 +0.0 +0.0 +0.3 +1.0 +1.7 +1.7 +0.4 +0.2 p+0.0	⁺ 0.0 ⁺ 0.0					+0.0 +0.0	PL-WP01 .6 ⁺ 0.6	+0.2 +	0.1
+0.0 +0.0 +0.0 + 0.4 + 1.4 +2.0 +1.8 +0.9 +0.3 +0.10 +0.0	+0.0 +0.0	+0.0 0.0 +0.0	⁺ 0.0			⁺ 0.0 ⁺ 0.0	⁺ 6.7 ⁺ 3.7 ⁺ 0.6	+0.2 +	0.1
+0.0 +0.0 +0.1 +0.5 +2.0 +2.4 +2.0 +0.3 +0.6 0.0	+0.0 +0.0	+0.0 +0.0 +0.0	+ <mark>0.0 ₹000 0.8</mark> ±0.0 ±0.0 ±0.0 ±0.0	0.0 0.0 0.0 0.0 PL-SG01	0.0 0.0 0.0 PL-SG01	+0.0 +0.0	+4.4 +2.3 +0.5	+0.2	0.3
+0.0 +0.1 +0.1 +0.4 +3.0 +3.2 +2.5 +0.3 +0.1 +0.0	+0.0 ⁺ 0.0	+0.0 +0.0 +0.0	+0.0 +0.0 +0.0 +0.0 +0.0 +0.0 +0.0 +1			2 ⁺ 6.5 ⁺ 2.0	+2.7 +1.6 +0.7	+0.4 +	0.6
+0.1 +0.1 +0.2 +0.5 +4.5 +4.3 +2.9 +0.5 +0.2 +0.5 +0.2	+0.0 +0.0		+0.0 +0.0 +0.0 +0.0 +0.0 +0.0 +0.0 +2	2.0 +3.1 +7.4+8.1	+4.0_0_+4.6_0_+10.	2 ⁺ 6_ø_ ⁺ 3.1	⁺ 2.2 ⁺ 1.8 ⁺ 1.4	+1,3 +.	1.6
<u>PLO2H</u>			⁺ 0.5 ⁺ 0.5 ⁺ 0.9 ⁺ 1.4 ⁺ 1.6 ⁺ 1.8 ⁺ 1.9 ⁺ 1	1.9 +2.7 +4.0 +4.5	⁺ 3.9 ⁺ 4.3 ⁺ 5.8	4.9 3.7	3.0 2.7 +2.4	12.4 +2	2.9
+0.1 +0.2 +0.3 +0.7 • • • • • • • • • •	+0.3 +0.3	⁺ 0.3 ⁺ 0.4 ⁺ 0.4	⁺ 0.4 ⁺ 0.5 ⁺ 0.6 ⁺ 0.8 ⁺ 1.0 ⁺ 1.2 ⁺ 1.3 ⁺ 1	.6 +2.0 +2.7 533	+3.7 & 3.9 & 4.2	4.26. 3.9	*3.6 *3.4 *3.2	*3.4 +	4.3
+0.1 +0.1 +0.3 +0.6 +6.9 +5.5 +4.3 +3.1 +2.4 +0.4 +0.4	+0.3 +0.3	*0.4 *0.4 *0.5	*0.5 *0.5 *0.5 *0.6 *0.9 *1.1 *1.2 *1	1.4 ⁺ 1.7 ⁺ 2.3 ⁺ 3.1	⁺ 3.9 ⁺ 4.5 ⁺ 4.7	⁺ 4.6 ⁺ 4.2	⁺ 4.1 ⁺ 4.3 ⁺ 4.4	4.9 +	6.3
+0.1 ⁺ 0.1 ⁺ 0.2 ⁺ 0.5 ⁺ 4.9 ⁺ 4.7 ⁺ 4.7 ⁺ 4.5 ⁺ 4.6 ⁺ 0.8 ⁺ 8.6	⁺ 0.5 ⁺ 0.4	⁺ 0.5 ⁺ 0.6 ⁺ 0.7	⁺ 0.6 ⁺ 0.6 ⁺ 0.7 ⁺ 0.9 ⁺ 1.2 ⁺ 1.3 ⁺ 1	1.4 ⁺ 1.7 ⁺ 2.3 ⁺ 3.3	⁺ 4.7 ⁺ 5.8 ⁺ 6.0 <u>PL03</u>	⁺ 5.5 ⁺ 4.8	⁺ 4.6 ⁺ 5.2 ⁺ 5.9	+6.9 +9 2L03	9.2
$\begin{array}{c ccccccccccccccccccccccccccccccccccc$	⁺ 0.8 ⁺ 0.7	⁺ 0.8 ⁺ 1.2 <u>PL04</u> 5	+12 +0.9 +0.8 +0.9 +1.3 <u>PL04</u> +(8 +1)	±.6 ⁺ 17 ⁺ 2.2 ⁺ 3.3	+ <u>4.9</u> + <u>6.3</u> + <u>6.5</u>	+ <u>5</u> .7 + <u>4.6</u>	4.5 +5.4 6.5	우 	11
	+3.7 +3.2	<u>+3.9</u> + <u>5.2</u> <u>1</u> .9		<u>1.4</u> 3.3 ⁺ 3.1 ⁺ 3.9	<u>+5.4</u> +7.1+7.3 PL04	+61 +5 .1	⁺ 5.0 6.0 ⁺7.5	<u>>L04</u>	<u>12</u>
$\begin{array}{c ccccccccccccccccccccccccccccccccccc$	4.9 4.7	⁺ 5.1 ⁺ 5.9 ⁺ 6.1	<u>+</u> + + + + + + + + + + + + + + + + + +	t.9 [−] 4.2 [−] 4.1 [−] 4.5	<u>5.5</u> <u>6.7</u> <u>6.9</u>	<u>+</u> + +	⁺ 5.2 *5.8 *6.7	+ +	10.
$\begin{array}{c ccccccccccccccccccccccccccccccccccc$	4.8 4.7	4.9 5.5 5.6	*5.4 *4.9 *4.6 *4.7 *5.1 5.3 5.2 *4	4.7 4.3 4.2 4.4	5.1 5.7 5.9	5.5 5.1	⁺ 5.0 * 4.3 * 5.6	6.2	7.6
$ \begin{array}{cccccccccccccccccccccccccccccccccccc$	4.0 4.0	⁺ 4.7 ⁺ 4.8 ⁺ 4.9 ⁺ 4.4 ⁺ 4.4 ⁺ 4.4		4.3 4.2 4.2 $4.34.0$ $+4.1$ $+4.1$ $+4.1$	⁺ 4.5 ⁺ 4.8 ⁺ 4.9 ⁺ 4.1 ⁺ 4.1 ⁺ 4.3	4.9 4.8 +4.5 +4.5	4.7 4.7 4.7 4.7	4.8	5.5
$\begin{array}{cccccccccccccccccccccccccccccccccccc$	4.3 4.3 +4.2 +4.3	⁺ 4.3 ⁺ 4.3 ⁺ 4.3			4.1 4.1 4.3 +4.0 +4.0 +4.2		4.4 4.4 4.1 +4 3 +4.3 +4.0	+3 7 +	4.2
$\begin{array}{cccccccccccccccccccccccccccccccccccc$	+ <u>4.2</u> + <u>.3</u>				⁺ 4.2 ⁺ 4.4 ⁺ 4.5		4.5 4.5 4.0	+4.0 +	3.6
+0.1 +0.2 +0.5 +1.0 +1.5 +2.1 +2.9 +3.7 +4.4 +4.8 +4.9	+4.7 +4.7	+4.9 +5.2 +5.4	⁺ 5.3 ⁺ 4.9 ⁺ 4.7 ⁺ 4.8 ⁺ 5.0 [†] 5.1 [†] 4.9 ⁺ 4	4.6 ⁺ 4.3 ⁺ 4.2 ⁺ 4.4	+4.8 +5.1 +5.3	+.0 +.0	+4.8 +4.9 +5.0	+4.7 +	4.1
+0.1 +0.2 +0.5 +0.9 +1.4 +2.0 +2.9 + <u>4.1 +5.3 +5.7</u> +5.6	⁺ 5.0 ⁺ 4.8	⁺ 5.2 ⁺ 6.1 ⁺ 6.2		5.0 ⁺ 4.4 ⁺ 4.2 ⁺ 4.5	+5.3 +6.0 +6.2	+5.8 +5.1	⁺ 4.9 ⁺ 5.4 ⁺ 5.9	+5.6 +	4.8
+0.1 +0.2 +0.4 +0.8 +1.3 +2.1 +3.2 +4.7 +6.6 +7.3 +6.4	⁺ 5.5 ⁺ 5.3	PL04 *5. <u>8 *7.0 *7.9</u>	PL04 1	5.6 ⁺ 4.6 ⁺ 4.3 ⁺ 4.7	<u>PL04</u>		₽ ⁺ 5.4 ⁺ 5<u>.9</u> ⁺7.1	<u>'LO4</u> + _{7.4} +	5.7
+0.1 +0.3 +0.4 +0.7 +1.2 +2.0 +3.3 +5.7 +8.5 +0.7 +8.5	⁺ 5.9 ⁺ 5.2	↓ + _{8.7} + PL01	<u>र</u>	6.7 + 4.0 +4.6		++	+5.1 6.5 +8.7		7.(
+0.2 +0.3 +0.6 +0.9 +1.2 +1.8 +2.8 +4.1 +5.8 +6.6 +5.8	⁺ 5.0 ⁺ 4.8	+5.3 +6.5 +7.3	⁺ 6.3 ⁺ 5.1 ⁺ 4.6 ⁺ 4.8 ⁺ 5.7 ⁺ 6.8 ⁺ 8.6 ⁺ 5	5.3 +4.3 +4.0 +4.3	+5.3 +6.6 +6.8	⁺ 5.7 ⁺ 4.9	+4.7 +5.2 +6.2	+6.4 +	5.0
+0.2 +0.4 +0.6 +0.9 +1.2 +1.6 +2.2 +2.8 +3.5 +3.9 +3.8	⁺ 3.8 ⁺ 3.9	⁺ 4.0 ⁺ 4.3 ⁺ 4.6	⁺ 4.3 ⁺ 40 ⁺ 3.8 ⁺ 3.8 ⁺ 3.9 ⁺ 4.3 ⁴ 4.2 ⁺ 3	3.8 ⁺ 3.5 ⁺ 3.4 ⁺ 3.6	⁺ 3.8 ⁺ 4.2 ⁺ 4.3	⁺ 4.0 ⁺ 3.8	⁺ 3.8 ⁺ 3.7 ⁺ 3.8	+3.7 +	3.1
+0.1 +0.3 +0.4 +0.6 +0.8 +1.0 +1.1 +1.2 +1.4 +1.6 +197	⁺ 1.9 ⁺ 2.0	+2.0 +2.0 +2.0	*2.0 *2.0 *2.0 *2.0 *1.9 *1.8 *1	I.8 ⁺ 1.9 ⁺ 2.0 ⁺ 1.9	⁺ 1.8 ⁺ 1.9 ⁺ 1.8	⁺ 1.8 ⁺ 1.9	⁺ 1.9 ⁺ 1.8 ⁺ 1.6	+1.4 +	1.3
+0.1 +0.1 +0.1 +0.2 +0.2 +0.2 +0.2 +0.3 +0.3 +0.4 +0.4	+0.4 +0.4	+0.5 +0.5 + 0.5	+0.5 +0.5 +0.4 +0.4 +0.5 +0.5 +0.5 +0.5	0.4 ⁺ 0.5 ⁺ 0.4 ⁺ 0.5	⁺ 0.4 ⁺ 0.5 ⁺ 0.5	⁺ 0.5 ⁺ 0.4	⁺ 0.4 ⁺ 0.4 ⁺ 0.4	+0.4 +	0.3
+0.0 0,0 +0.0 +0.1 +0.1 +0.1 +0.1 +0.1 +0.2 +0.2 +0.2	+0.2 +0.2	⁺ 0.2 ⁺ 0.2 ⁺ 0.2	**************************************	0.2 ⁺ 0.2 ⁺ 0.2 ⁺ 0.2	+0.2 +0.2 +0.2	+0.2 +0.2	+0.2 +0.2 +0.2	+0.2 +	0.2
+0.0 +0.0 +0.0 +0.0 +0.1 +0.1 +0.1 +0.1	*0.1 *0.1	+0.1 0.1 0/1	a lang a - ja	0.1 ⁺ 0.1 ⁺ 0.1 ⁺ 0.1	⁺ 0.1 ⁺ 0.1 ⁺ 0.1	+0.1 +0.1	⁺ 0.1 ⁺ 0.1 ⁺ 0.1	+0.1 +	0.1
0.0 +0.0 +0.0 +0.0 +0.0 +0.0 +0.1 +0.1 +	⁺ 0.1 ⁺ 0.1	+0.1 +0.1 0.1 0.1	<u>+ + + + + + + + + + + + + + + + + + + </u>	0.1 0.1 0.1 0.1	⁺ 0.1 ⁺ 0.1 ⁺ 0.1	+0.1 +0.1	+0.1 +0.1 +0.1	+0.1 +	0.1

0.0 +0.0 +0.0


0.0 +0.0 +0.0


0.0 +0.0 +0.0

0.0 +0.0 +0.0

0.0 +0.0 +0.0

SITE PHOTOMETRIC PLAN 1" = 30'-0"

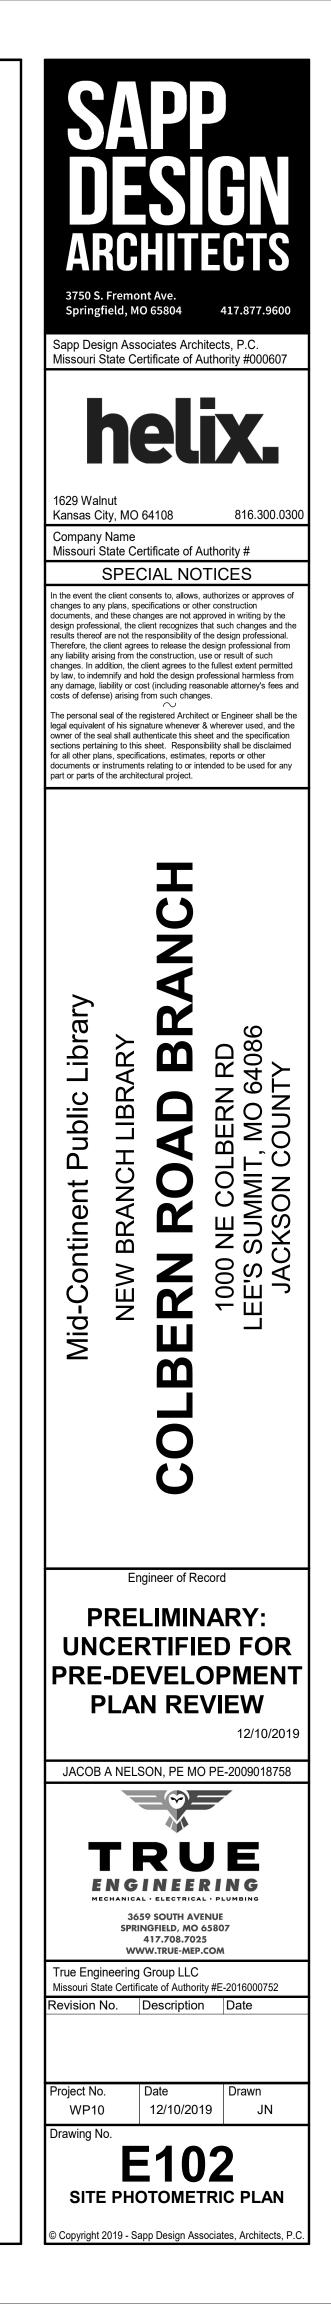


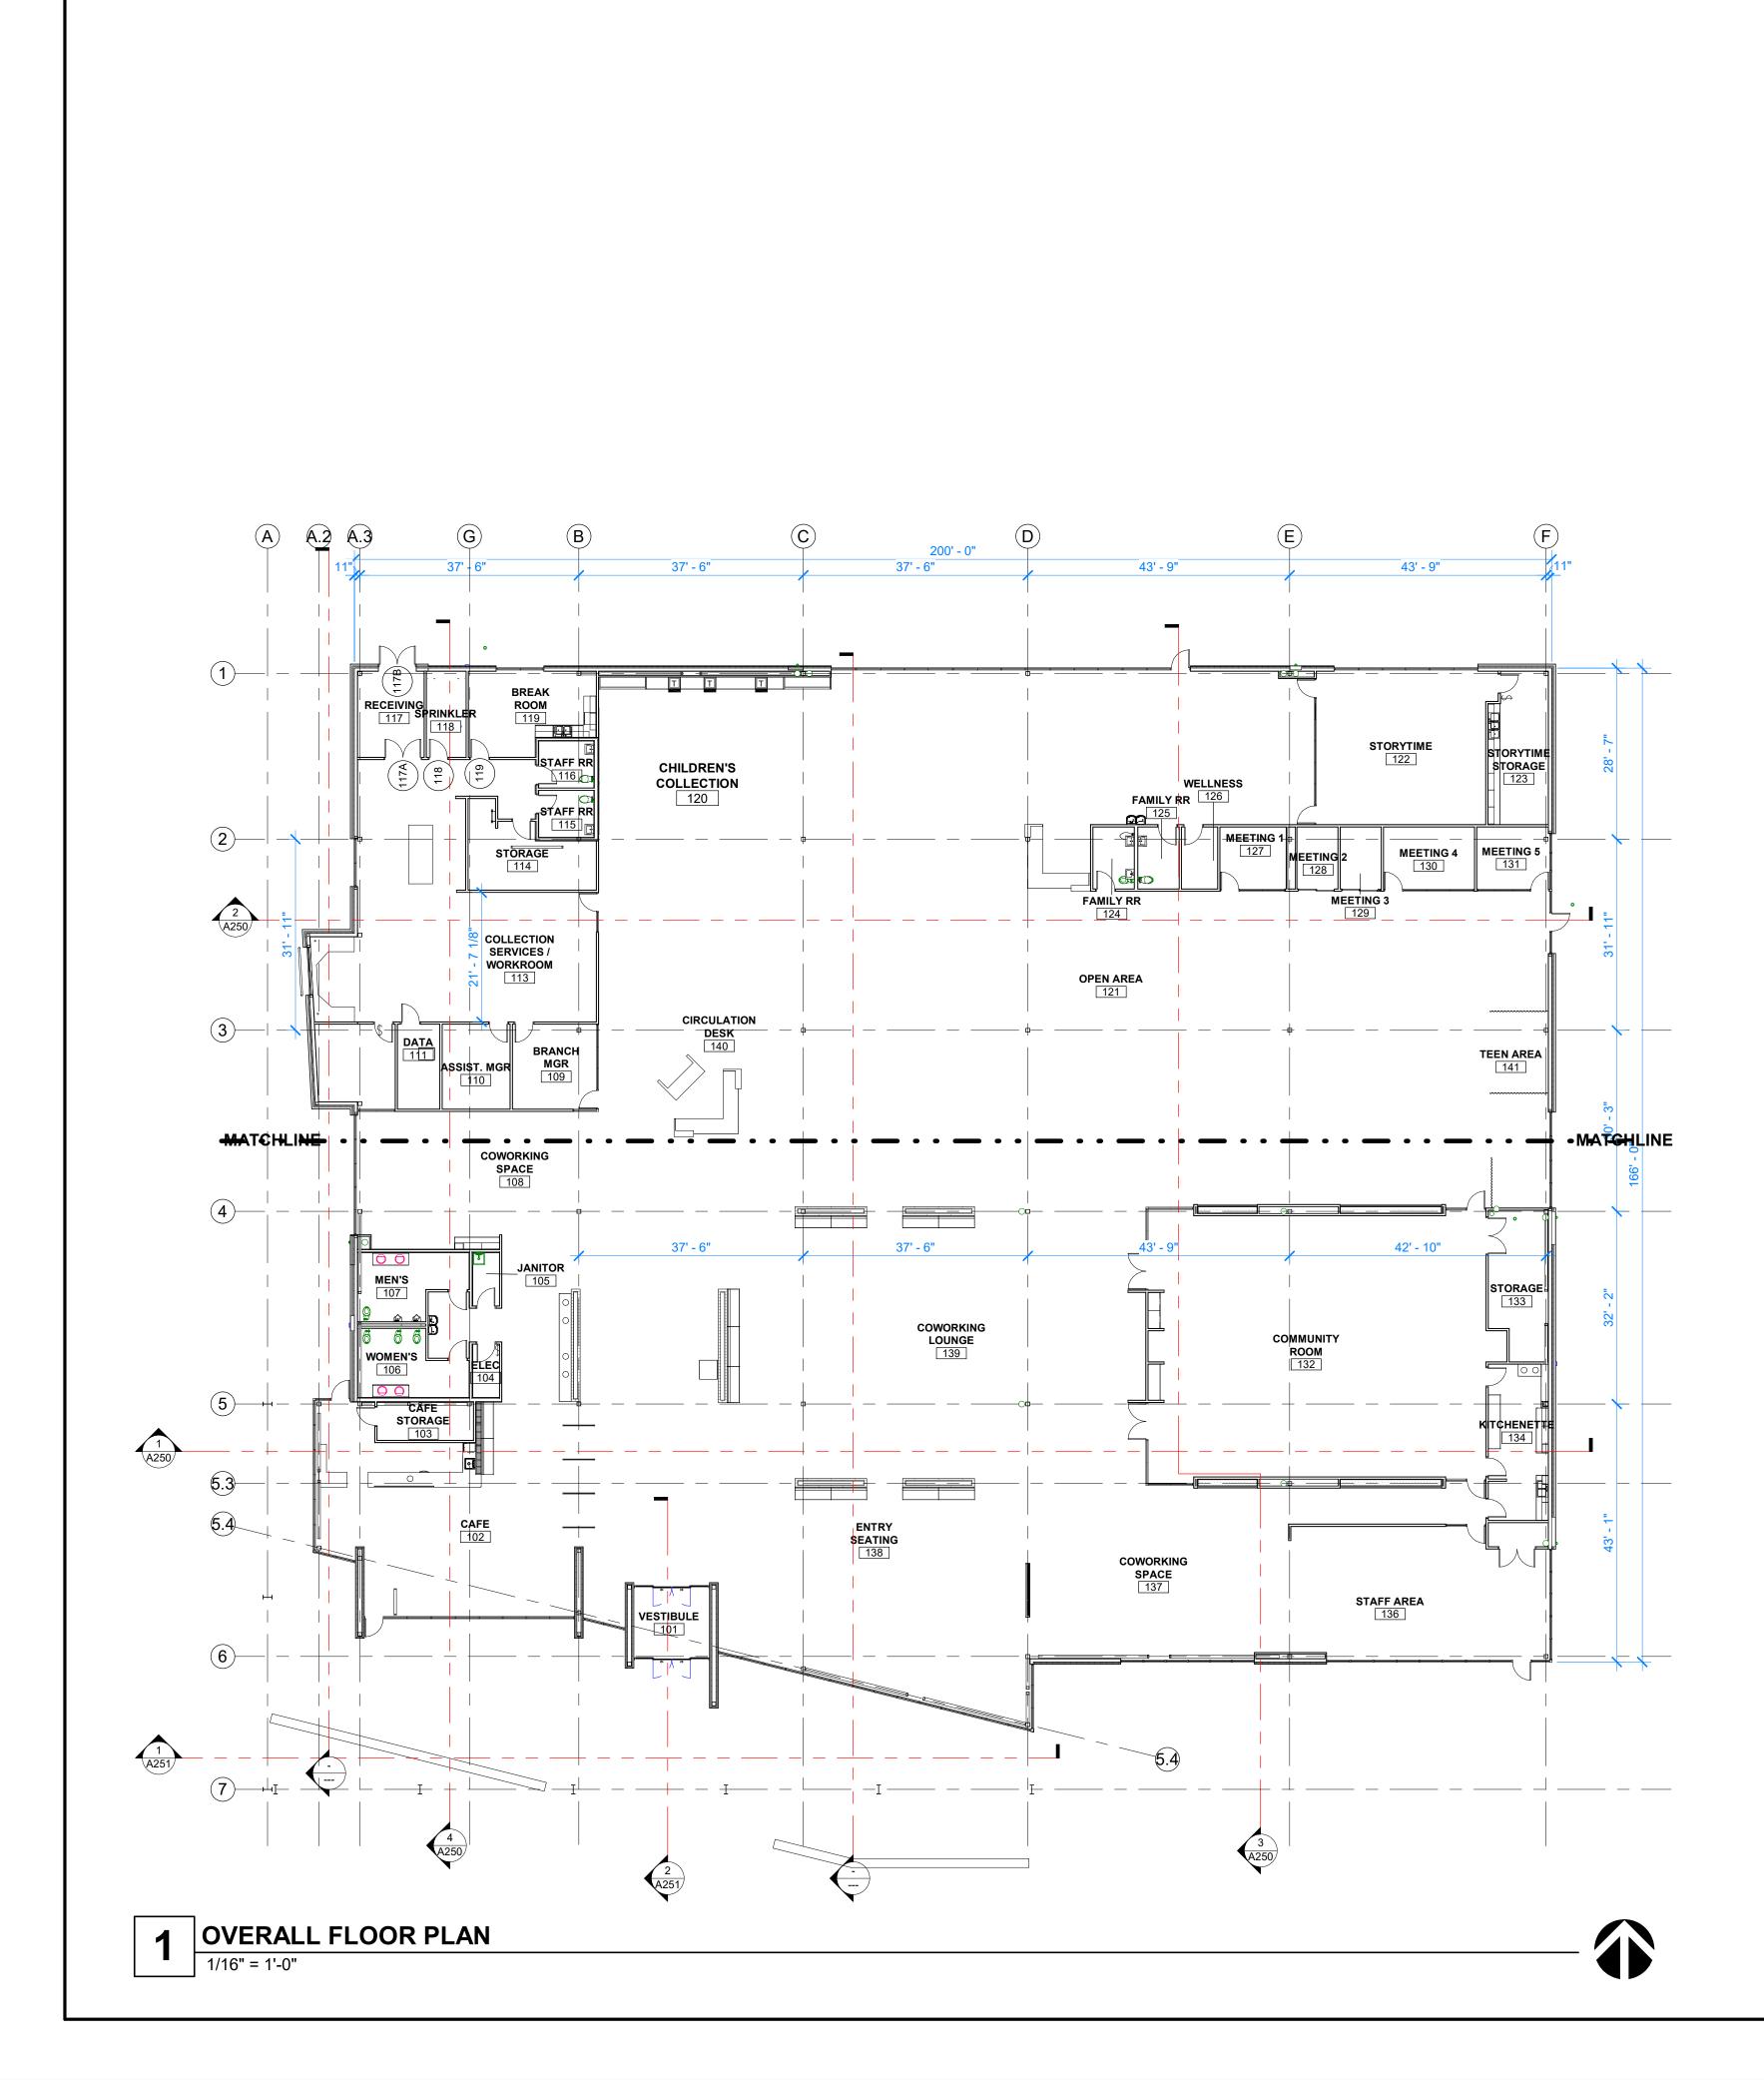

KEYNOTES	СЛПП
	SAPP
	JESIGN
	ARCHITECTS
	3750 S. Fremont Ave. Springfield, MO 65804 417.877.9600
	Sapp Design Associates Architects, P.C. Missouri State Certificate of Authority #000607
	helix.
	1629 Walnut
	Kansas City, MO 64108816.300.0300Helix Architecture + DesignMissouri State Certificate of Authority #000720
	SPECIAL NOTICES In the event the client consents to, allows, authorizes or approves of changes to any plans, specifications or other construction documents, and these changes are not approved in writing by the
	design professional, the client recognizes that such changes and the results thereof are not the responsibility of the design professional. Therefore, the client agrees to release the design professional from any liability arising from the construction, use or result of such changes. In addition, the client agrees to the fullest extent permitted by law, to indemnify and hold the design professional harmless from
	any damage, liability or cost (including reasonable attorney's fees and costs of defense) arising from such changes.
	sections pertaining to this sheet. Responsibility shall be disclaimed for all other plans, specifications, estimates, reports or other documents or instruments relating to or intended to be used for any part or parts of the architectural project.
	L C
	: Library RARY Bran ROAD JRI 64086 JTY
	Iblic LIBR SOUI SOUI
	Mid-Continent Public Library NEW BRANCH LIBRARY Ibern Road Brai 1000 NE COLBERN ROAD LEE'S SUMMIT, MISSOURI 6408 JACKSON COUNTY
	Itiner BRAI BRAI BRAI CKSO
	Mid-Conti NEW B I bern 1000 NE LEE'S SUMI JACK
	Architect of Record
	PRELIMINARY SET
	NOT FOR CONSTRUCTION
	PRELIMINARY: UNCERTIFIED FOR PRE-DEVELOPMENT
	PLAN REVIEW - NOV 8, 2019
	Revision No. Description Date
	Project No. Date Drawn WP10 11-8-2019 TLK
	Drawing No.
	OVERALL FLOOR PLAN
	© Copyright 2019 - Sapp Design Associates, Architects, P.C.

1)---



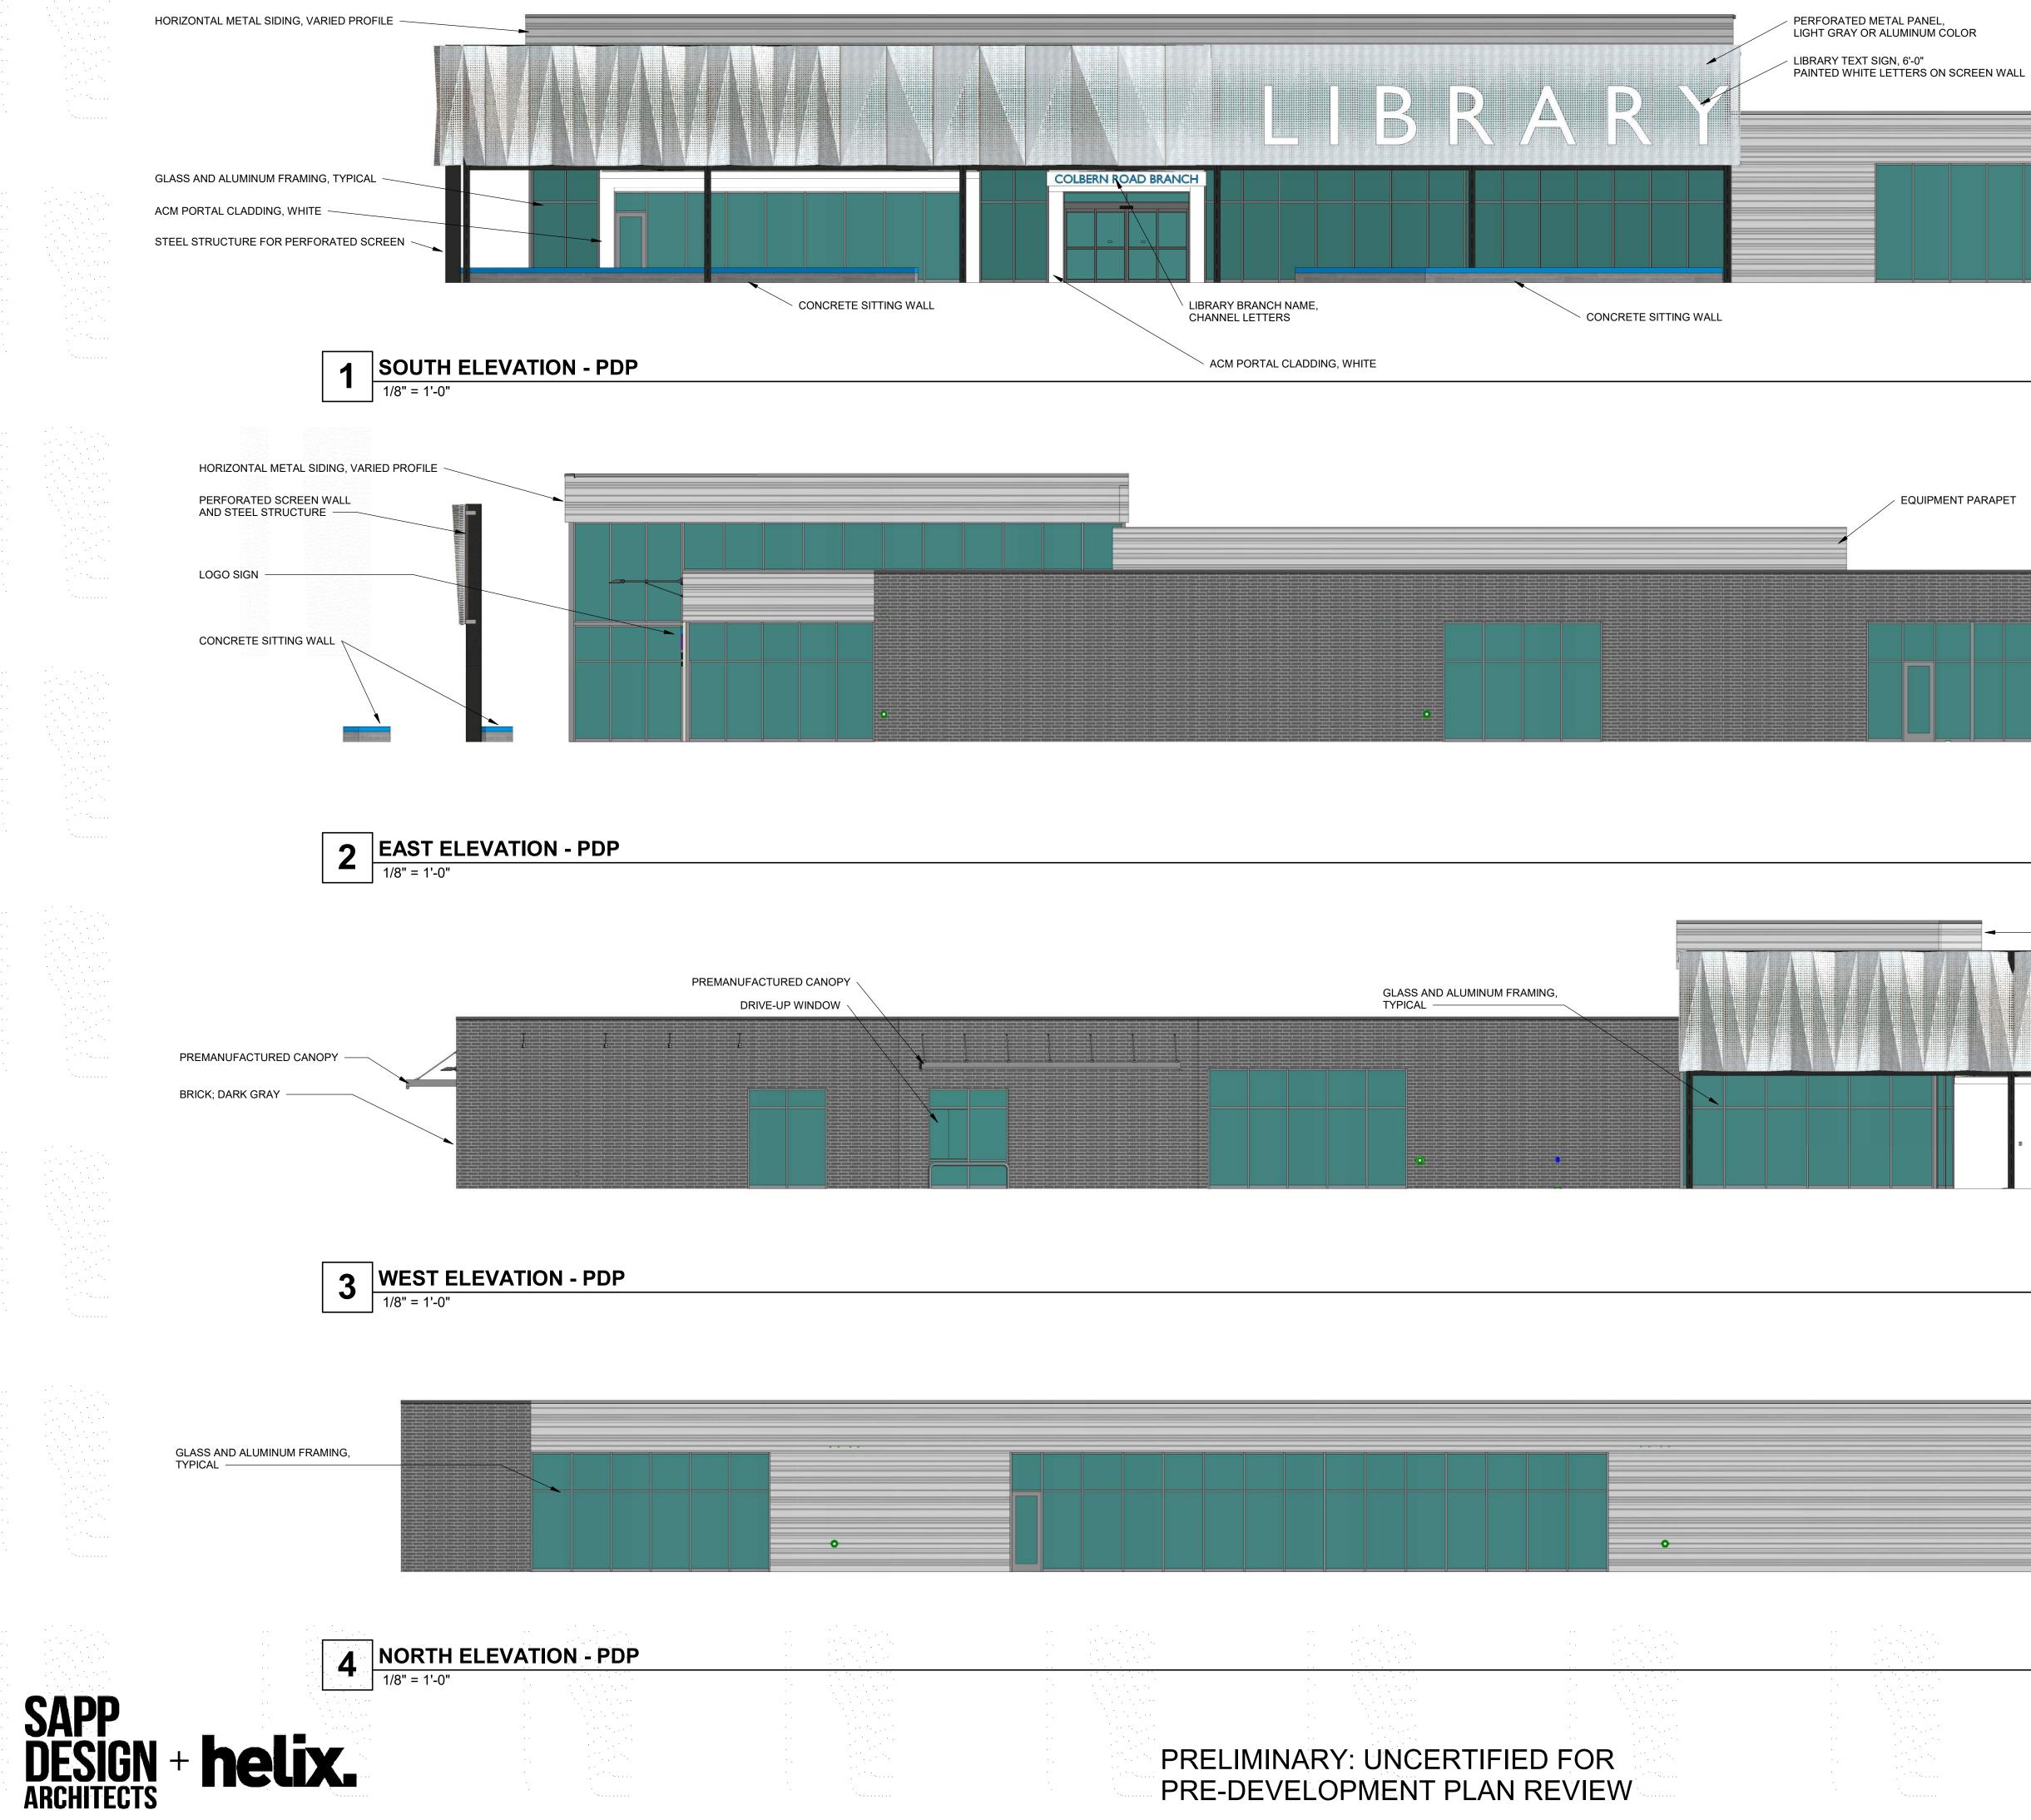

	RTAL CLADDING, WHITE		
			EQUIPMENT P.
	GLASS AND ALUMINUM TYPICAL	FRAMING,	
PRELIN PRE-DE	INARY: UNCERTIF	IED FOR NREVIEW	

/ LOGO SIGN WITH LIGHTING 91 MID - CONTINENT PUBLIC LIBRARY PARAPET BRICK, DARK GRAY GLASS AND ALUMINUM FRAMING, TYPICAL -- HORIZONTAL METAL SIDING, VARIED PROFILE -PERFORATED SCREEN WALL - ACM PORTAL CLADDING CONCRETE SITTING WALL - HORIZONTAL METAL SIDING, VARIED PROFILE -PREMANUFACTURED CANOPY BRICK, DARK GRAY
 1/3 BOND

11/08/19 **Colbern Road Branch** Mid-Continent Public Library










PRELIMINARY: UNCERTIFIED FOR PRE-DEVELOPMENT PLAN REVIEW

11/08/19 Colbern Road Branch Mid-Continent Public Library

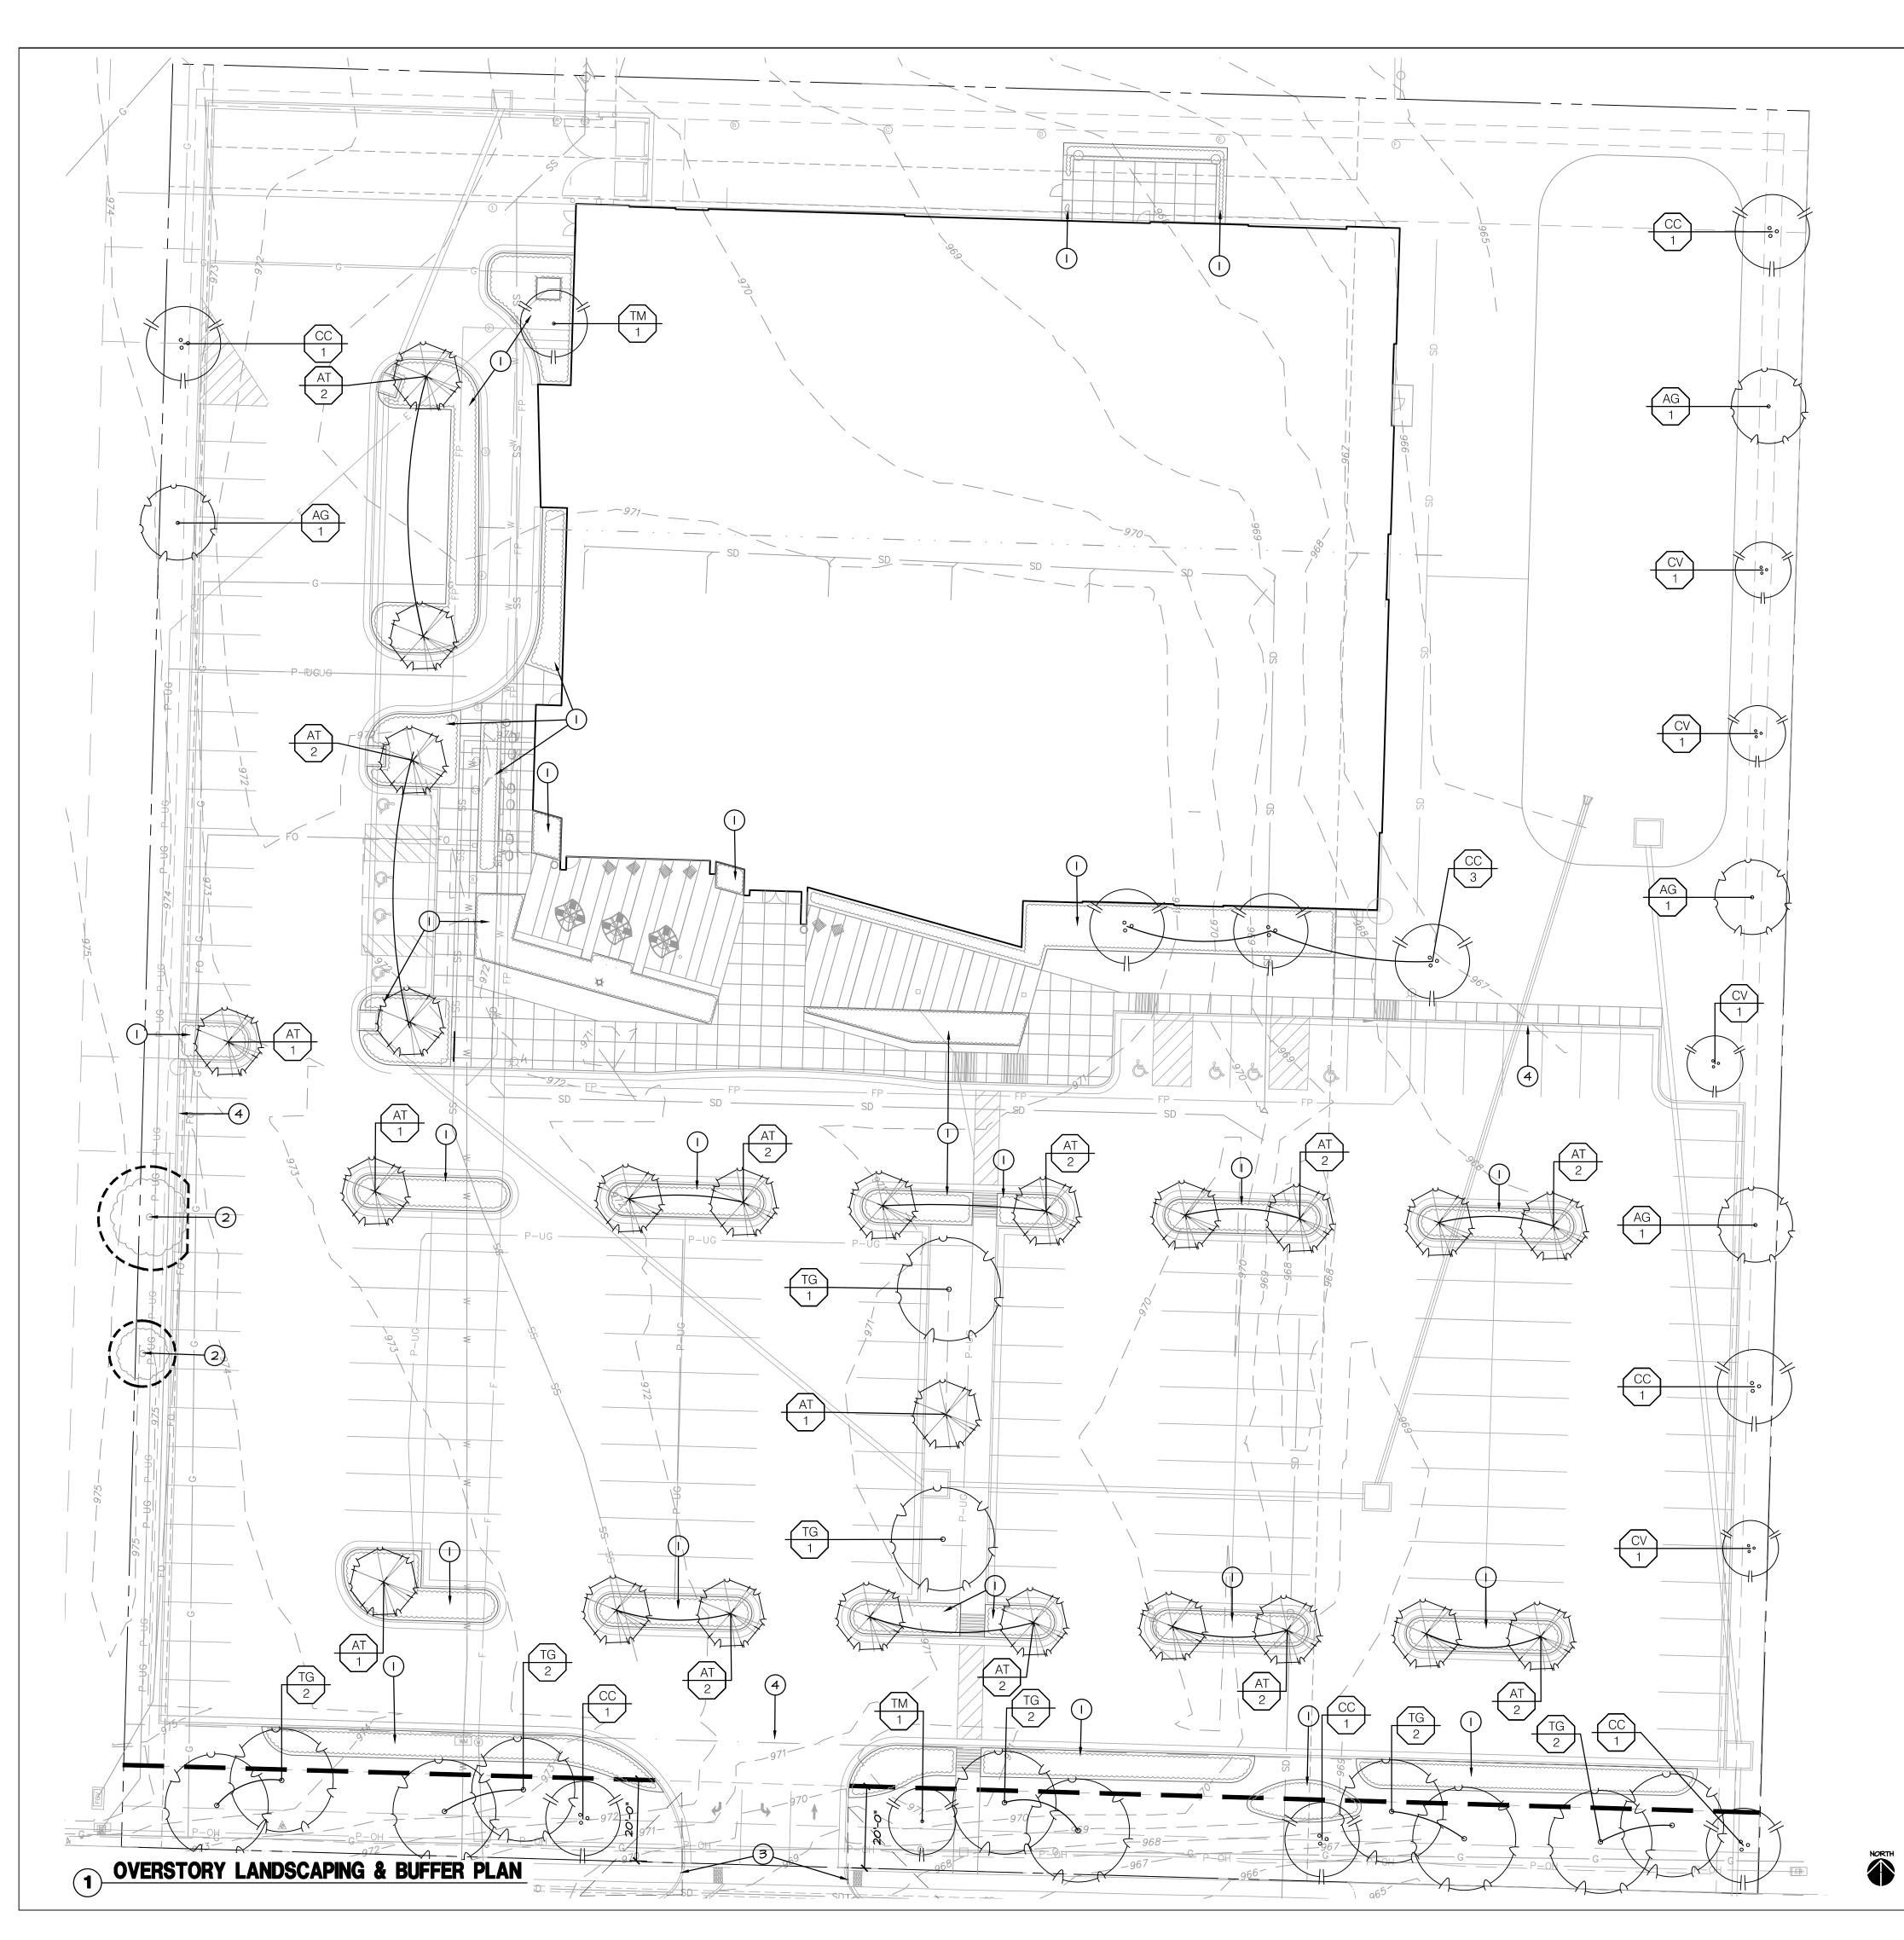

18. PLANT KEY DESCRIPTION.


RIGHT OF WAY / PROPERTY LINE ---- TREE PROTECTION FENCING 20' LANDSCAPE BUFFER ÷.

(1)

LANDSCAPE GENERAL NOTES:

I. THE CONSTRUCTION COVERED BY THESE PLANS SHALL CONFORM TO ALL APPLICABLE STANDARDS AND SPECIFICATIONS OF THE CITY OF LEE'S SUMMIT, MISSOURI IN CURRENT USAGE. ALL STANDARDS NOT COVERED BY THE CITY SHALL BE APWA STANDARDS IN CURRENT USAGE UNLESS OTHERWISE NOTED.

- 2. CONTRACTOR SHALL VERIFY EXACT LOCATION OF ALL EXISTING UTILITIES, DRAIN LINES AND IRRIGATION PIPING PRIOR TO COMMENCING WORK AND AGREES TO BE FULLY RESPONSIBLE FOR ANY AND ALL DAMAGES WHICH MIGHT BE OCCASIONED BY THE CONTRACTOR'S FAILURE TO EXACTLY LOCATE AND PRESERVE ANY AND ALL UNDERGROUND UTILITIES, DRAIN LINES AND IRRIGATION PIPING.
- 3. CONTRACTOR SHALL VERIFY AND COORDINATE ALL FINAL GRADES WITH LANDSCAPE ARCHITECT PRIOR TO COMPLETION.
- 4. DEBRIS SHALL NOT BE ALLOWED TO ACCUMULATE AND SHALL BE REMOVED AT FREQUENT INTERVALS. AT COMPLETION OF WORK IN EACH AREA, THE CONTRACTOR SHALL GATHER AND REMOVE ALL DEBRIS, EQUIPMENT, AND EXCESS MATERIAL FROM THAT AREA. AT FINAL COMPLETION OF ALL WORK HE SHALL REMOVE ALL SUCH ITEMS FROM THE PREMISES.
- 5. LOCATION AND PLACEMENT OF ALL PLANT MATERIAL SHALL BE COORDINATED WITH LANDSCAPE ARCHITECT PRIOR TO INSTALLATION.
- 6. THE LANDSCAPE PLANTING PLAN GRAPHICALLY ILLUSTRATES OVERALL PLANT MASSINGS. EACH PLANT SPECIES SHALL BE PLACED IN THE FIELD TO UTILIZE THE GREATEST COVERAGE OF THE GROUND PLANE. THE FOLLOWING APPLIES FOR INDIVIDUAL PLANTINGS:
 - -ALL EVERGREEN SHRUBS AND CREEPING GROUNDCOVERS SHALL BE MINIMUM OF 2' FROM ANY PAVING EDGE. -ALL PLANTS OF THE SAME SPECIES SHALL BE EQUALLY SPACED AND SITED FOR THE BEST AESTHETIC VIEWING. -ALL TREES, EVERGREEN OR DECIDUOUS, SHALL BE A MINIMUM OF 4' FROM ANY PAVING EDGE.
- 7. ANY SUBSTITUTION OF SPECIFIED PLANT MATERIAL WILL NOT BE ALLOWED WITHOUT WRITTEN AUTHORIZATION FROM LANDSCAPE ARCHITECT PRIOR TO INSTALLATION.
- 8. MULCH ALL PLANTING AREAS TO A DEPTH OF 3" DEPTH ACCORDING TO PLANS AND SPECIFICATIONS. SAMPLES SHALL BE APPROVED BY LANDSCAPE ARCHITECT.
- 9. ALL PLANT MATERIAL WILL BE HEALTHY, VIGOROUS AND FREE OF DISEASE AND INSECTS PER AAN STANDARDS. LANDSCAPE ARCHITECT RESERVES THE RIGHT TO REJECT ANY INFERIOR OR OTHERWISE UNSUITABLE PLANT MATERIAL PROPOSED FOR USE ON THE PROJECT.
- IO. ALL PLANTING BEDS NOT FULLY CONTAINED BY CONCRETE CURBS OR WALKS SHALL BE EDGED ACCORDING TO PLANS AND SPECIFICATIONS.
- II. PLANTS AND LANDSCAPE MATERIALS SHALL BE INSTALLED AS DETAILED ON PLANS. 12. PLANT BACKFILL FOR TREES AND SHRUBS SHALL BE PER SPECIFICATIONS.
- 13. ALL PLANTING BEDS SHALL BE TREATED WITH DACTHAL PRE-EMERGENT HERBICIDE AT MANUFACTURER RECOMMENDED RATES AND SHALL BE COVERED WITH SPECIFIED MULCH APPLICATION. APPLY LIGHTER APPLICATION OF DACTHAL HERBICIDE TO TOP OF MULCH LAYER.
- 14. ALL AREAS DISTURBED DURING CONSTRUCTION THAT ARE NOT DESIGNATED AS PLANTING BEDS OR PAVEMENT AREAS SHALL BE SEEDED WITH A TURF TYPE TALL FESCUE PER SPECIFICATIONS.
- 15. ALL PLANT MATERIAL SHALL BE GUARANTEED FOR A PERIOD OF ONE YEAR AFTER OWNER'S FINAL ACCEPTANCE OF FINISHED JOB. ALL DEAD AND DAMAGED PLANT MATERIAL SHALL BE REPLACED BY LANDSCAPE CONTRACTOR AT THEIR EXPENSE. LANDSCAPE CONTRACTOR SHALL MAINTAIN PLANT MATERIAL UNTIL FINAL ACCEPTANCE.
- 16. ALL LANDSCAPE BEDS SHALL BE MOUNDED AS SHOWN ON PLANS AND DETAILS. 17. LANDSCAPE CONTRACTOR SHALL BE RESPONSIBLE FOR VERIFYING ACTUAL PLANT QUANTITIES REQUIRED TO COMPLETE THE PROJECT AS SHOWN ON THE PLANS, AND BASE THEIR BID ACCORDINGLY.

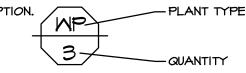

EXISTING TREE TO REMAIN

OVERSTORY TREE

ORNAMENTAL TREE

EVERGREEN TREE

LANDSCAPE LEGEND:

SHRUB BED

LANDSCAPE PLAN NOTES:

PLANTING BED WITH HARDWOOD MULCH; REF: LANDSCAPE GENERAL NOTES, LANDSCAPE DETAILS &SPECIFICATIONS

- (2) EXISTING TREE TO REMAIN
 - SIGHT TRIANGLES

0 10' 20' 40'

PARKING LOT PERIMETER USED FOR 5% CALCULATION



Sapp Design Associates Architects, P.C. Missouri State Certificate of Authority #000607




1629 Walnut Kansas City, MO 64108


816.300.0300

SPECIAL NOTICES

In the event the client consents to, allows, authorizes or approves of changes to any plans, specifications or other construction documents, and these changes are not approved in writing by the design professional, the client recognizes that such changes and the results thereof are not the responsibility of the design professional. Therefore, the client agrees to release the design professional from any liability arising from the construction, use or result of such changes. In addition, the client agrees to the fullest extent permitted by law, to indemnify and hold the design professional harmless from any damage, liability or cost (including reasonable attorney's fees and costs of defense) arising from such changes. \sim


The personal seal of the registered Architect or Engineer shall be the legal equivalent of his signature whenever & wherever used, and the owner of the seal shall authenticate this sheet and the specification sections pertaining to this sheet. Responsibility shall be disclaimed for all other plans, specifications, estimates, reports or other documents or instruments relating to or intended to be used for any part or parts of the architectural project.

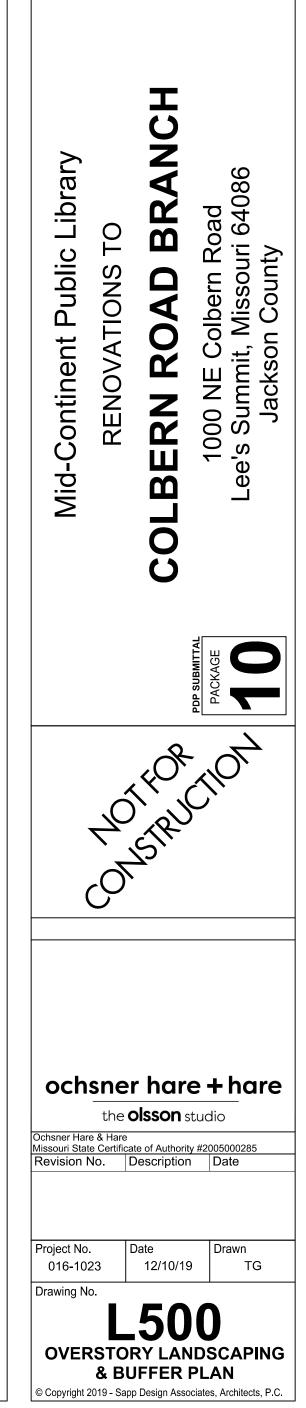

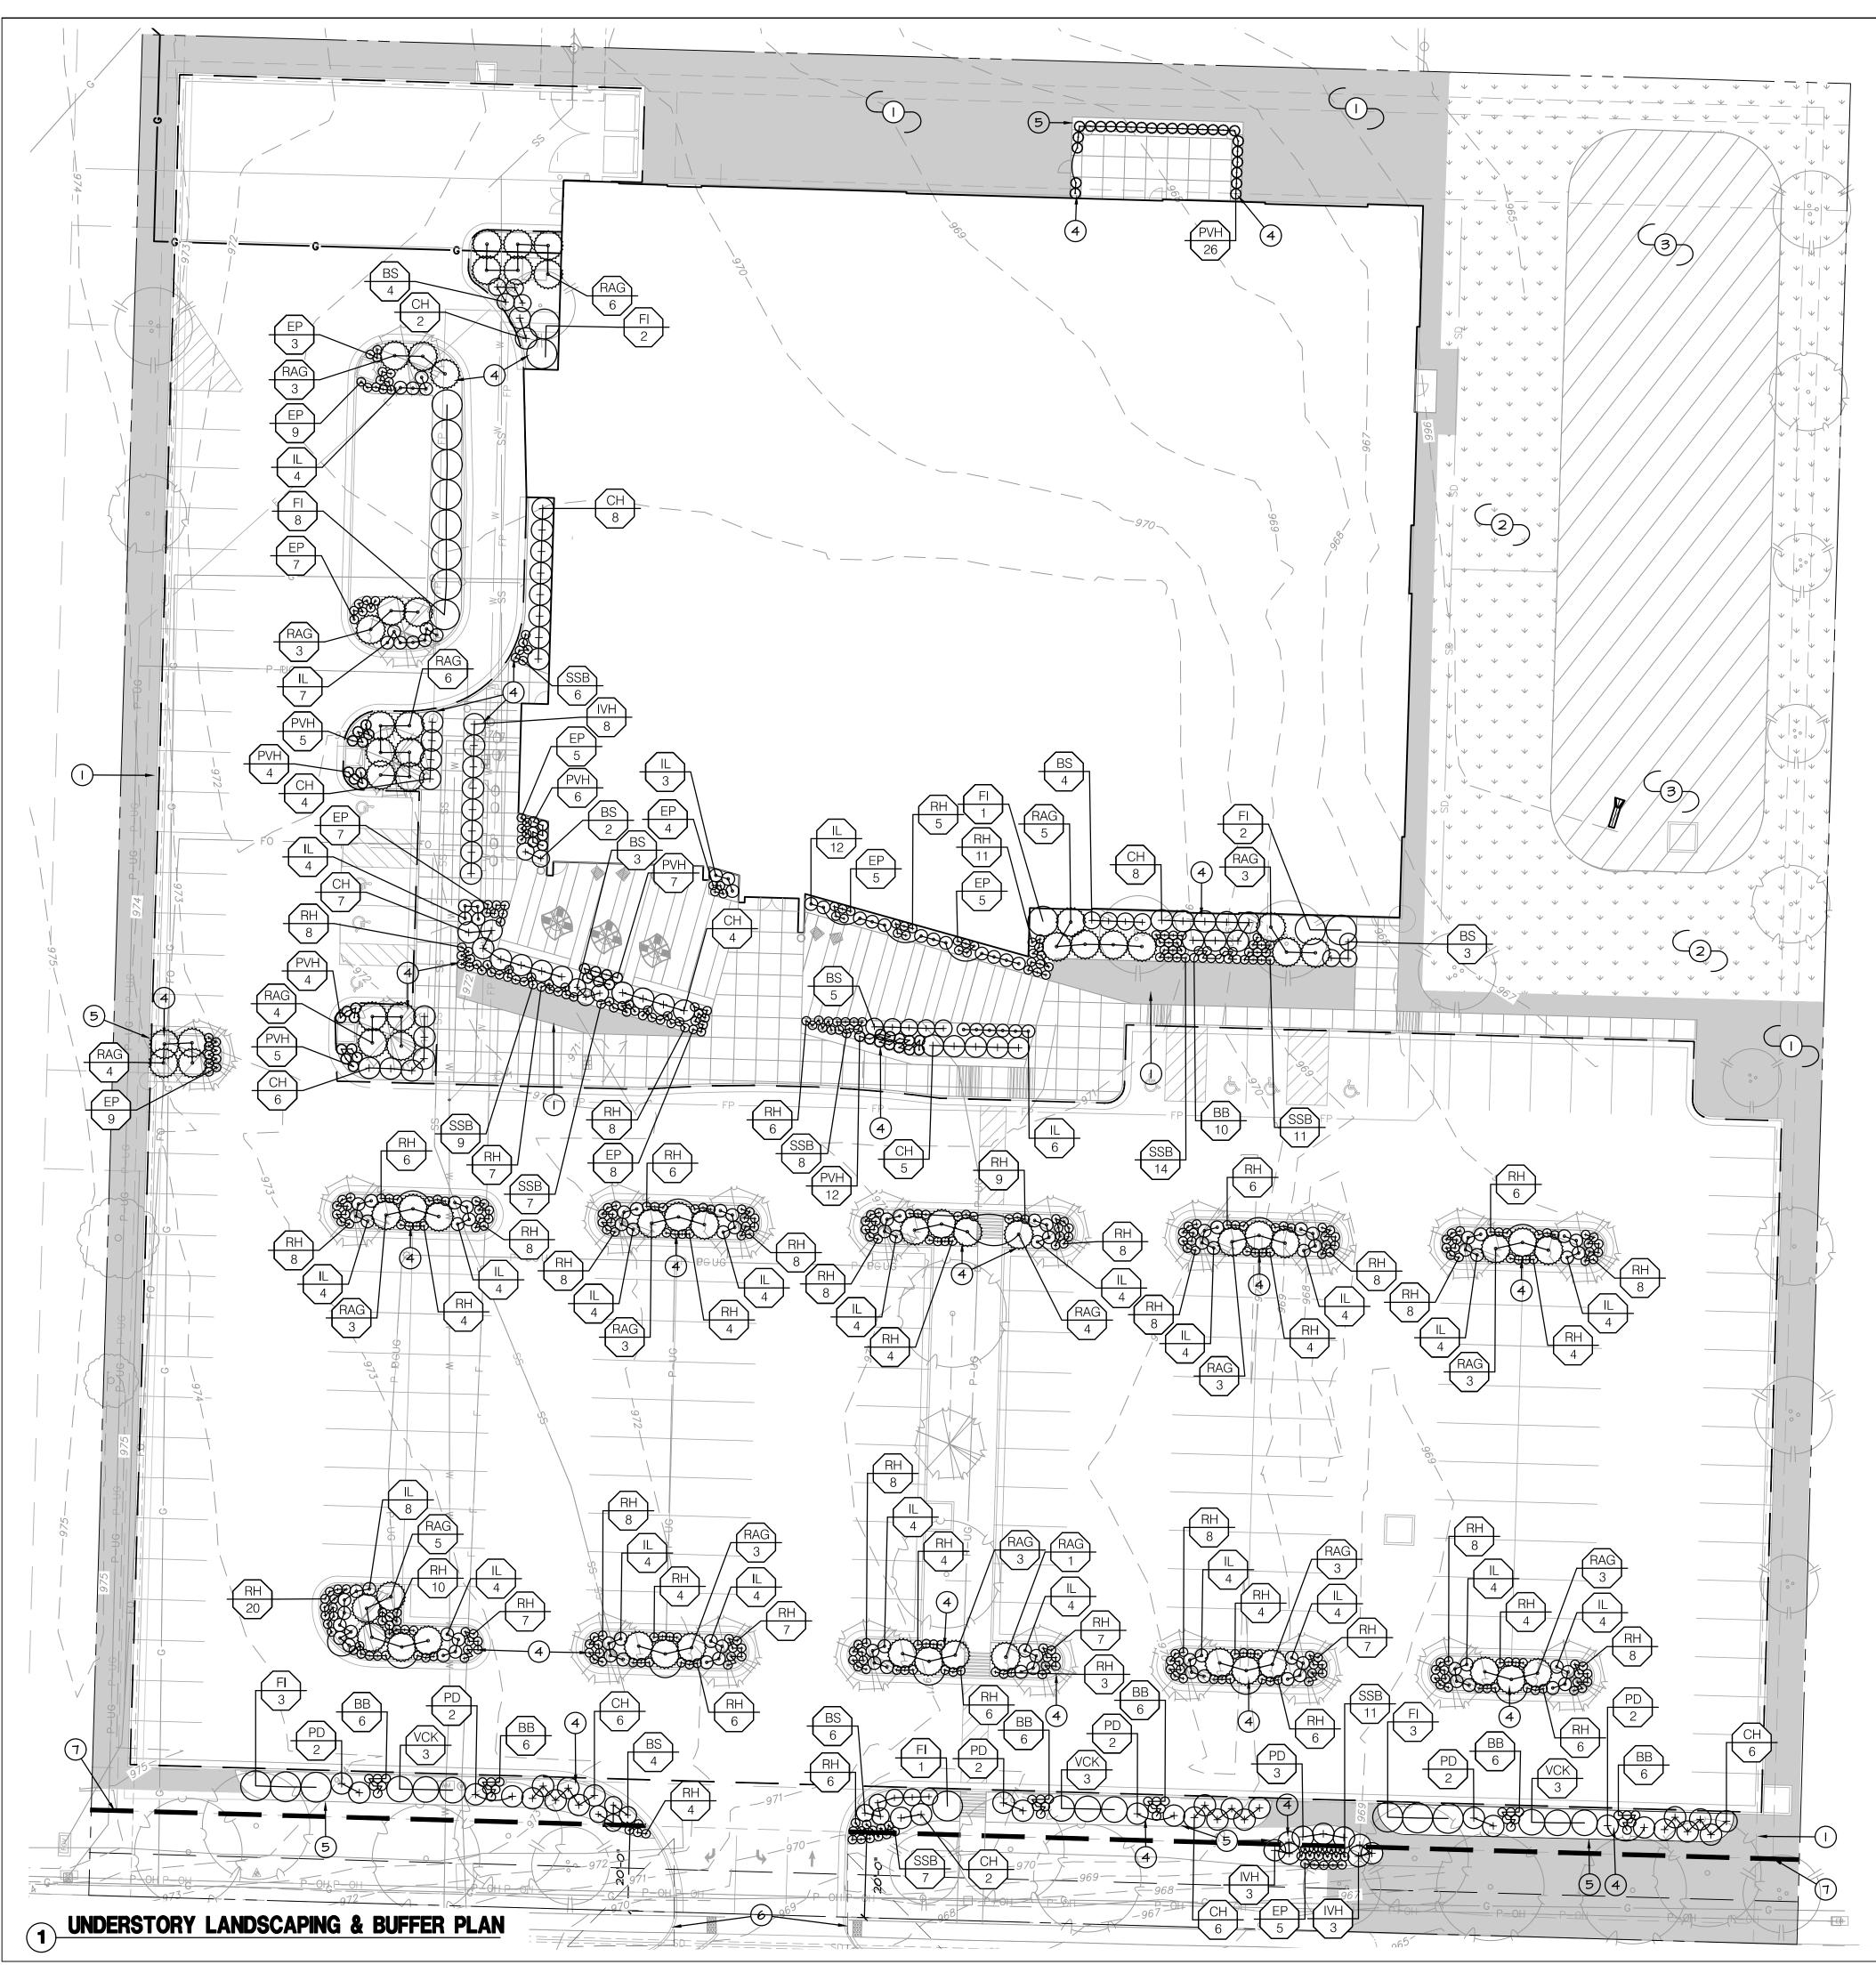

- FROM THE PREMISES.
- INDIVIDUAL PLANTINGS: FROM ANY PAVING EDGE. THE BEST AESTHETIC VIEWING. PAVING EDGE.
- SPECIFICATIONS. SAMPLES SHALL BE APPROVED BY LANDSCAPE ARCHITECT.
- USE ON THE PROJECT.

- OF MULCH LAYER.
- FESCUE PER SPECIFICATIONS.
- ACCEPTANCE.
- BASE THEIR BID ACCORDINGLY.
- 18. PLANT KEY DESCRIPTION.

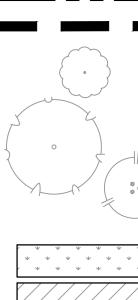

LANDSCAPE PLAN NOTES:

	AREA TO BE SC
2	AREA TO BE SE
3	AREA TO BE SE
4	PLANTING BED LANDSCAPE DE
5	STEEL BED EDG
6	SIGHT TRIANGLE
T	20' LANDSCAPE

NORTH

0 10' 20'

LANDSCAPE GENERAL NOTES:

THE CONSTRUCTION COVERED BY THESE PLANS SHALL CONFORM TO ALL APPLICABLE STANDARDS AND SPECIFICATIONS OF THE CITY OF LEE'S SUMMIT, MISSOURI IN CURRENT USAGE. ALL STANDARDS NOT COVERED BY THE CITY SHALL BE APWA STANDARDS IN CURRENT USAGE UNLESS OTHERWISE NOTED.

2. CONTRACTOR SHALL VERIFY EXACT LOCATION OF ALL EXISTING UTILITIES, DRAIN LINES AND IRRIGATION PIPING PRIOR TO COMMENCING WORK AND AGREES TO BE FULLY RESPONSIBLE FOR ANY AND ALL DAMAGES WHICH MIGHT BE OCCASIONED BY THE CONTRACTOR'S FAILURE TO EXACTLY LOCATE AND PRESERVE ANY AND ALL UNDERGROUND UTILITIES, DRAIN LINES AND IRRIGATION PIPING.

3. CONTRACTOR SHALL VERIFY AND COORDINATE ALL FINAL GRADES WITH LANDSCAPE ARCHITECT PRIOR TO COMPLETION.

4. DEBRIS SHALL NOT BE ALLOWED TO ACCUMULATE AND SHALL BE REMOVED AT FREQUENT INTERVALS. AT COMPLETION OF WORK IN EACH AREA, THE CONTRACTOR SHALL GATHER AND REMOVE ALL DEBRIS, EQUIPMENT, AND EXCESS MATERIAL FROM THAT AREA. AT FINAL COMPLETION OF ALL WORK HE SHALL REMOVE ALL SUCH ITEMS

5. LOCATION AND PLACEMENT OF ALL PLANT MATERIAL SHALL BE COORDINATED WITH LANDSCAPE ARCHITECT PRIOR TO INSTALLATION.

6. THE LANDSCAPE PLANTING PLAN GRAPHICALLY ILLUSTRATES OVERALL PLANT MASSINGS. EACH PLANT SPECIES SHALL BE PLACED IN THE FIELD TO UTILIZE THE GREATEST COVERAGE OF THE GROUND PLANE. THE FOLLOWING APPLIES FOR -ALL EVERGREEN SHRUBS AND CREEPING GROUNDCOVERS SHALL BE MINIMUM OF 2' -ALL PLANTS OF THE SAME SPECIES SHALL BE EQUALLY SPACED AND SITED FOR

-ALL TREES, EVERGREEN OR DECIDUOUS, SHALL BE A MINIMUM OF 4' FROM ANY

7. ANY SUBSTITUTION OF SPECIFIED PLANT MATERIAL WILL NOT BE ALLOWED WITHOUT WRITTEN AUTHORIZATION FROM LANDSCAPE ARCHITECT PRIOR TO INSTALLATION. 8. MULCH ALL PLANTING AREAS TO A DEPTH OF 3" DEPTH ACCORDING TO PLANS AND

9. ALL PLANT MATERIAL WILL BE HEALTHY, VIGOROUS AND FREE OF DISEASE AND INSECTS PER AAN STANDARDS. LANDSCAPE ARCHITECT RESERVES THE RIGHT TO REJECT ANY INFERIOR OR OTHERWISE UNSUITABLE PLANT MATERIAL PROPOSED FOR

IO. ALL PLANTING BEDS NOT FULLY CONTAINED BY CONCRETE CURBS OR WALKS SHALL BE EDGED ACCORDING TO PLANS AND SPECIFICATIONS.


II. PLANTS AND LANDSCAPE MATERIALS SHALL BE INSTALLED AS DETAILED ON PLANS. 12. PLANT BACKFILL FOR TREES AND SHRUBS SHALL BE PER SPECIFICATIONS.

13. ALL PLANTING BEDS SHALL BE TREATED WITH DACTHAL PRE-EMERGENT HERBICIDE AT MANUFACTURER RECOMMENDED RATES AND SHALL BE COVERED WITH SPECIFIED MULCH APPLICATION. APPLY LIGHTER APPLICATION OF DACTHAL HERBICIDE TO TOP

14. ALL AREAS DISTURBED DURING CONSTRUCTION THAT ARE NOT DESIGNATED AS PLANTING BEDS OR PAVEMENT AREAS SHALL BE SEEDED WITH A TURF TYPE TALL

15. ALL PLANT MATERIAL SHALL BE GUARANTEED FOR A PERIOD OF ONE YEAR AFTER OWNER'S FINAL ACCEPTANCE OF FINISHED JOB. ALL DEAD AND DAMAGED PLANT MATERIAL SHALL BE REPLACED BY LANDSCAPE CONTRACTOR AT THEIR EXPENSE. LANDSCAPE CONTRACTOR SHALL MAINTAIN PLANT MATERIAL UNTIL FINAL

16. ALL LANDSCAPE BEDS SHALL BE MOUNDED AS SHOWN ON PLANS AND DETAILS. 17. LANDSCAPE CONTRACTOR SHALL BE RESPONSIBLE FOR VERIFYING ACTUAL PLANT QUANTITIES REQUIRED TO COMPLETE THE PROJECT AS SHOWN ON THE PLANS, AND

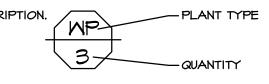

LANDSCAPE LEGEND:

- - RIGHT OF WAY / PROPERTY LINE 20' LANDSCAPE BUFFER EXISTING TREE

OVERSTORY TREE

ORNAMENTAL TREE

FESCUE SEED MIX

DETENTION BASIN SEED MIX

TURF TYPE FESCUE SOD

ODDED WITH TURF TYPE FESCUE; REF: SPECIFICATIONS EEDED WITH FESCUE SEED; REF: SPECIFICATIONS EEDED; DETENTION BASIN MIX TO BE DETERMINED

WITH HARDWOOD MULCH; REF: LANDSCAPE GENERAL NOTES, ETAILS & SPECIFICATIONS

E BUFFER





1629 Walnut Kansas City, MO 64108

816.300.0300

SPECIAL NOTICES

In the event the client consents to, allows, authorizes or approves of changes to any plans, specifications or other construction documents, and these changes are not approved in writing by the design professional, the client recognizes that such changes and the results thereof are not the responsibility of the design professional. Therefore, the client agrees to release the design professional from any liability arising from the construction, use or result of such changes. In addition, the client agrees to the fullest extent permitted by law, to indemnify and hold the design professional harmless from any damage, liability or cost (including reasonable attorney's fees and costs of defense) arising from such changes. \sim

The personal seal of the registered Architect or Engineer shall be the legal equivalent of his signature whenever & wherever used, and the owner of the seal shall authenticate this sheet and the specification sections pertaining to this sheet. Responsibility shall be disclaimed for all other plans, specifications, estimates, reports or other documents or instruments relating to or intended to be used for any part or parts of the architectural project.

C

Ζ

BR

O

BERN


O

Ū

Libr Public -IONS Jt Contine Ο RENC Mid-

Ω 0 <u>ь</u>4 0 ntv 1000 s Su ee-

 \bigcirc 2015 RUCH

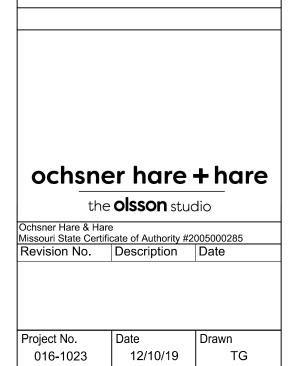

_50′

UNDERSTORY LANDSCAPING

& BUFFER PLAN

© Copyright 2019 - Sapp Design Associates, Architects, P.C.

Drawing No.

ORDINANCE REQUIREMENT

LANDSCAPE ISLANDS, STRIPS AND PLANTING AREAS SHALL CONSTITUTE AT LEAST FIVE PERCENT (5%) OF THE ENTIRE AREA DEVOTED TO PARKING.

STREET FRONT

KEY BOTANICAL NAME SHADE TREES

TG Tilia cordata 'Greenspire' TM Taxodium distichum 'Mickelson'

ORNAMENTAL TREES

CC Cercis canadensis

ORDINANCE REQUIREMENT

ONE (I) TREE PER 30 LINEAR FEET OF STREET FRONTAGE.

KEY BOTANICAL NAME SHADE TREES Acer truncatum AT Tilia cordata 'Greenspire' Taxodium distichum 'Mickelson' ΤG тм ORNAMENTAL TREES CC Cercis canadensis CV Chionanthus Virginicus

OPEN YARD TREES - PLANT SCHEDULE COND. QUANTITY SIZE COMMON NAME 3" CAL. 3" CAL. 3" CAL. SHANTUNG MAPLE GREENSPIRE LITTLELEAF LINDEN B₿B 24 B & B B & B 2 SHAWNEE BRAVE BALD CYPRESS 3" CAL. 3" CAL. AG Amelanchier x Grandiflora 'Autumn Brilliance' AUTUMN BRILLIANCE SERVICEBERRY BŧB 4 EASTERN REDBUD B₿₿ 6 3" CAL. B&B WHITE FRINGETREE 4 ORDINANCE REQUIREMENT ONE (I) TREE PER 5000 SQ. FT. OF TOTAL LOT AREA EXCLUDING BUILDING FOOTPRINT (IN ADDITION TO STREET TREES). 174,380.3 SQ. FT. OF TOTAL LOT AREA MINUS 33,792.5 SQ. FT. OF BUILDING FOOTPRINT = 140,587.8 SF 140,587.8 SQ. FT. / 5000 = 29 TREES REQUIRED TOTAL PROPOSED 41

PARKING LOT LANDSCAPE - AREA CALCULATIONS

TOTAL PARKING LOT AREA = 79,703 SQ FT

FIVE PERCENT (5%) OF 79,703 = 3,9851 SQ FT TOTAL LANDSCAPE AREA = 4,426 SQ FT

AGE TREES - PLANT SCHEDULE									
	COMMON NAME	SIZE	COND.	QUANTITY					
	GREENSPIRE LITTLELEAF LINDEN SHAWNEE BRAVE BALD CYPRESS	3" CAL. 3" CAL.	8 & 8 8 & 8	0 -					
	EASTERN REDBUD	3" CAL.	B¢B	З					

400 FT. OF STREET FRONTAGE / 30 = 14 TREES REQUIRED TOTAL PROPOSED 14

OF	PEN YARD SHRUBS	- F
KEY	BOTANICAL NAME	0
DEC	LIDUOUS SHRUBS	
BB CH	Buddleja Davidii 'Blue Chip' Cornus alba 'Bailhalo'	
Сп Fl	Forsythia X intermedia	IV0¶ B0R
 I∨H	ltea virginica 'Henry's Garnet'	HENF
IL	ltea virginica 'Little Henry'	VIRC
EVE	RGREEN SHRUBS	
RAG	Rhus Aromatica 'Gro-Low'	GRC
PER	ENNIALS / GRASSES	
BS	Baptistia 'Solar Flare'	SOL
EP	Echinacea purpurea	PURF
P∨H RH	Panicum virgatum 'Heavy Metal' Budbackia fulgida apaciasa (Caldahum)	HEA' GOL
кп SSB	Rudbeckia fulgida speciosa 'Goldsturm' Schizachyrium Scoparium	
ORE	DINANCE REQUIREMENT	
TWO	(2) SHRUBS PER 5000 SQ. FT. OF TOTAL LC	OT AR
PA	RKING LOT SCREE	NI
AN	ID STREET FRONTA	٩G
KEY		
BB	Buddleja Davidii 'Blue Chip'	
CH FI	Conversion Pollegia	DWA
I∕H	Cornus alba 'Bailhalo' Earsuthia X Intermedia	170
PD	Forsythia X intermedia	IV0 B0R
VCK	Forsythia X intermedia Itea virginica 'Henry's Garnet'	170
PFR	Forsythia X intermedia	IVO BOR HENR
	Forsythia X intermedia Itea virginica 'Henry's Garnet' Physocarpus opulifolius 'Diabolo'	IVO BOR HENF DIAE
BS	Forsythia X intermedia Itea virginica 'Henry's Garnet' Physocarpus opulifolius 'Diabolo' Viburnum carlesii	IVO BOR HENF DIAE
	Forsythia X intermedia Itea virginica 'Henry's Garnet' Physocarpus opulifolius 'Diabolo' Viburnum carlesii ENNIALS / GRASSES Baptista 'Solar Flare' Echinacea purpurea	IVOI BOR HENF DIAT KOR SOL/ PURF
BS EP RH	Forsythia X intermedia Itea virginica 'Henry's Garnet' Physocarpus opulifolius 'Diabolo' Viburnum carlesii ENNIALS / GRASSES Baptista 'Solar Flare' Echinacea purpurea Rudbeckia fulgida speciosa 'Goldsturm'	IVOI BOR HENF DIAE KOR
BS EP	Forsythia X intermedia Itea virginica 'Henry's Garnet' Physocarpus opulifolius 'Diabolo' Viburnum carlesii ENNIALS / GRASSES Baptista 'Solar Flare' Echinacea purpurea	IVOI BOR HENF DIAT KOR SOL/ PURF
BS EP RH SSB	Forsythia X intermedia Itea virginica 'Henry's Garnet' Physocarpus opulifolius 'Diabolo' Viburnum carlesii ENNIALS / GRASSES Baptista 'Solar Flare' Echinacea purpurea Rudbeckia fulgida speciosa 'Goldsturm'	IVOI BOR HENF DIAE KOR
BS EP RH SSB ORDIN	Forsythia X intermedia Itea virginica 'Henry's Garnet' Physocarpus opulifolius 'Diabolo' Viburnum carlesii ENNIALS / GRASSES Baptista 'Solar Flare' Echinacea purpurea Rudbeckia fulgida speciosa 'Goldsturm' Schhizachyrium Scoparium	SOL/ PURF GOLI

PLANT SCHEDULE								
COMMON NAME	SIZE	COND.	QUANTITY					
VARF BUTTERFLY BUSH ORY HALO DOGWOOD ORDER FORSYTHIA NRY'S GARNET SWEETSPIRE RGINIA SWEETSPIRE	5 GAL. 5 GAL. 5 GAL. 5 GAL. 5 GAL.	CONT. CONT. CONT. CONT. CONT.	10 44 13 8 120					
RO-LOW FRAGRANT SUMAC	5 GAL.	CONT.	68					
DLAR FLARE FALSE INDIGO RPLE CONE FLOWER AVY METAL SWITCHGRASS DLDSTURM BLACK-EYED SUSAN ITLE BLUESTEM	I GAL. I GAL. I GAL. I GAL. I GAL.	CONT. CONT. CONT. CONT. CONT.	21 62 69 319 55					
		1						

REA EXCLUDING BUILDING FOOTPRINT.


5 SQ. FT. OF BUILDING FOOTPRINT = 140,587.8 SQ. FT.

140,587.8 SQ. FT. / 5000 x 2 =

57 SHRUBS REQUIRED TOTAL PROPOSED 791

ING			
GE SHRUBS - P	LANT S	CHE	DULE
COMMON NAME	SIZE	COND.	QUANTITY
MARF BUTTERFLY BUSH /ORY HALO DOGWOOD ORDER FORSYTHIA ENRY'S GARNET SWEETSPIRE ABLOLO NINEBARK OREANSPICE VIBURNUM	5 GAL. 3 GAL. 3 GAL. 5 GAL. 5 GAL. 5 GAL.	CONT. CONT. CONT. CONT. CONT. CONT.	36 20 7 6 15 9
DLAR FLARE FALSE INDIGO RPLE CONE FLOWER DLDSTURM BLACK-EYED SUSAN ITLE BLUESTEM	I GAL. I GAL. I GAL. I GAL.	CONT. CONT. CONT. CONT.	0 5 0 8
ET TALL); MUST BE AT LEAST LEAST 2.5' IN HEIGHT AT CATIONS.			
III SH	RUBS REQUIRED	TOTAL	PROPOSED 136

Spring	Fremon field, MO	t Ave. 65804	D GGN ECTS 417.877.9600 itects, P.C.						
Missouri S			uthority #000607						
In the event the changes to any documents, an design profess results thereof Therefore, the any liability aris changes. In ad by law, to inder any damage, li costs of defens The personal s legal equivalen owner of the se sections pertai for all other pla	1629 Walnut Kansas City, MO 64108 816.300.0300 SPECIAL NOTICES In the event the client consents to, allows, authorizes or approves of changes to any plans, specifications or other construction documents, and these changes are not approved in writing by the design professional, the client recognizes that such changes and the results thereof are not the responsibility of the design professional. Therefore, the client agrees to release the design professional from any liability arising from the construction, use or result of such changes. In addition, the client agrees to the fullest extent permitted by law, to indemnify and hold the design professional harmless from any damage, liability or cost (including reasonable attorney's fees and costs of defense) arising from such changes. The personal seal of the registered Architect or Engineer shall be the legal equivalent of his signature whenever & wherever used, and the owner of the seal shall authenticate this sheet and the specification sections pertaining to this sheet. Responsibility shall be disclaimed for all other plans, specifications, estimates, reports or other documents or instruments relating to or intended to be used for any								
Mid-Continent Public Library	RENOVATIONS TO	COLBERN ROAD BRANCH	1000 NE Colbern Road Lee's Summit, Missouri 64086 Jackson County						
	PP SUBMITAL PACKAGE								
Ochsner Har Missouri Stat	ochsner hare + hare the olsson studio Ochsner Hare & Hare Missouri State Certificate of Authority #2005000285 Revision No. Description								
016-102 Drawing No OVERST P	Project No. 016-1023 Date 12/10/19 TG Drawing No. L502 VERSTORYAND UNDERSTORY PLANT SCHEDULE © Copyright 2019 - Sapp Design Associates, Architects, P.C.								

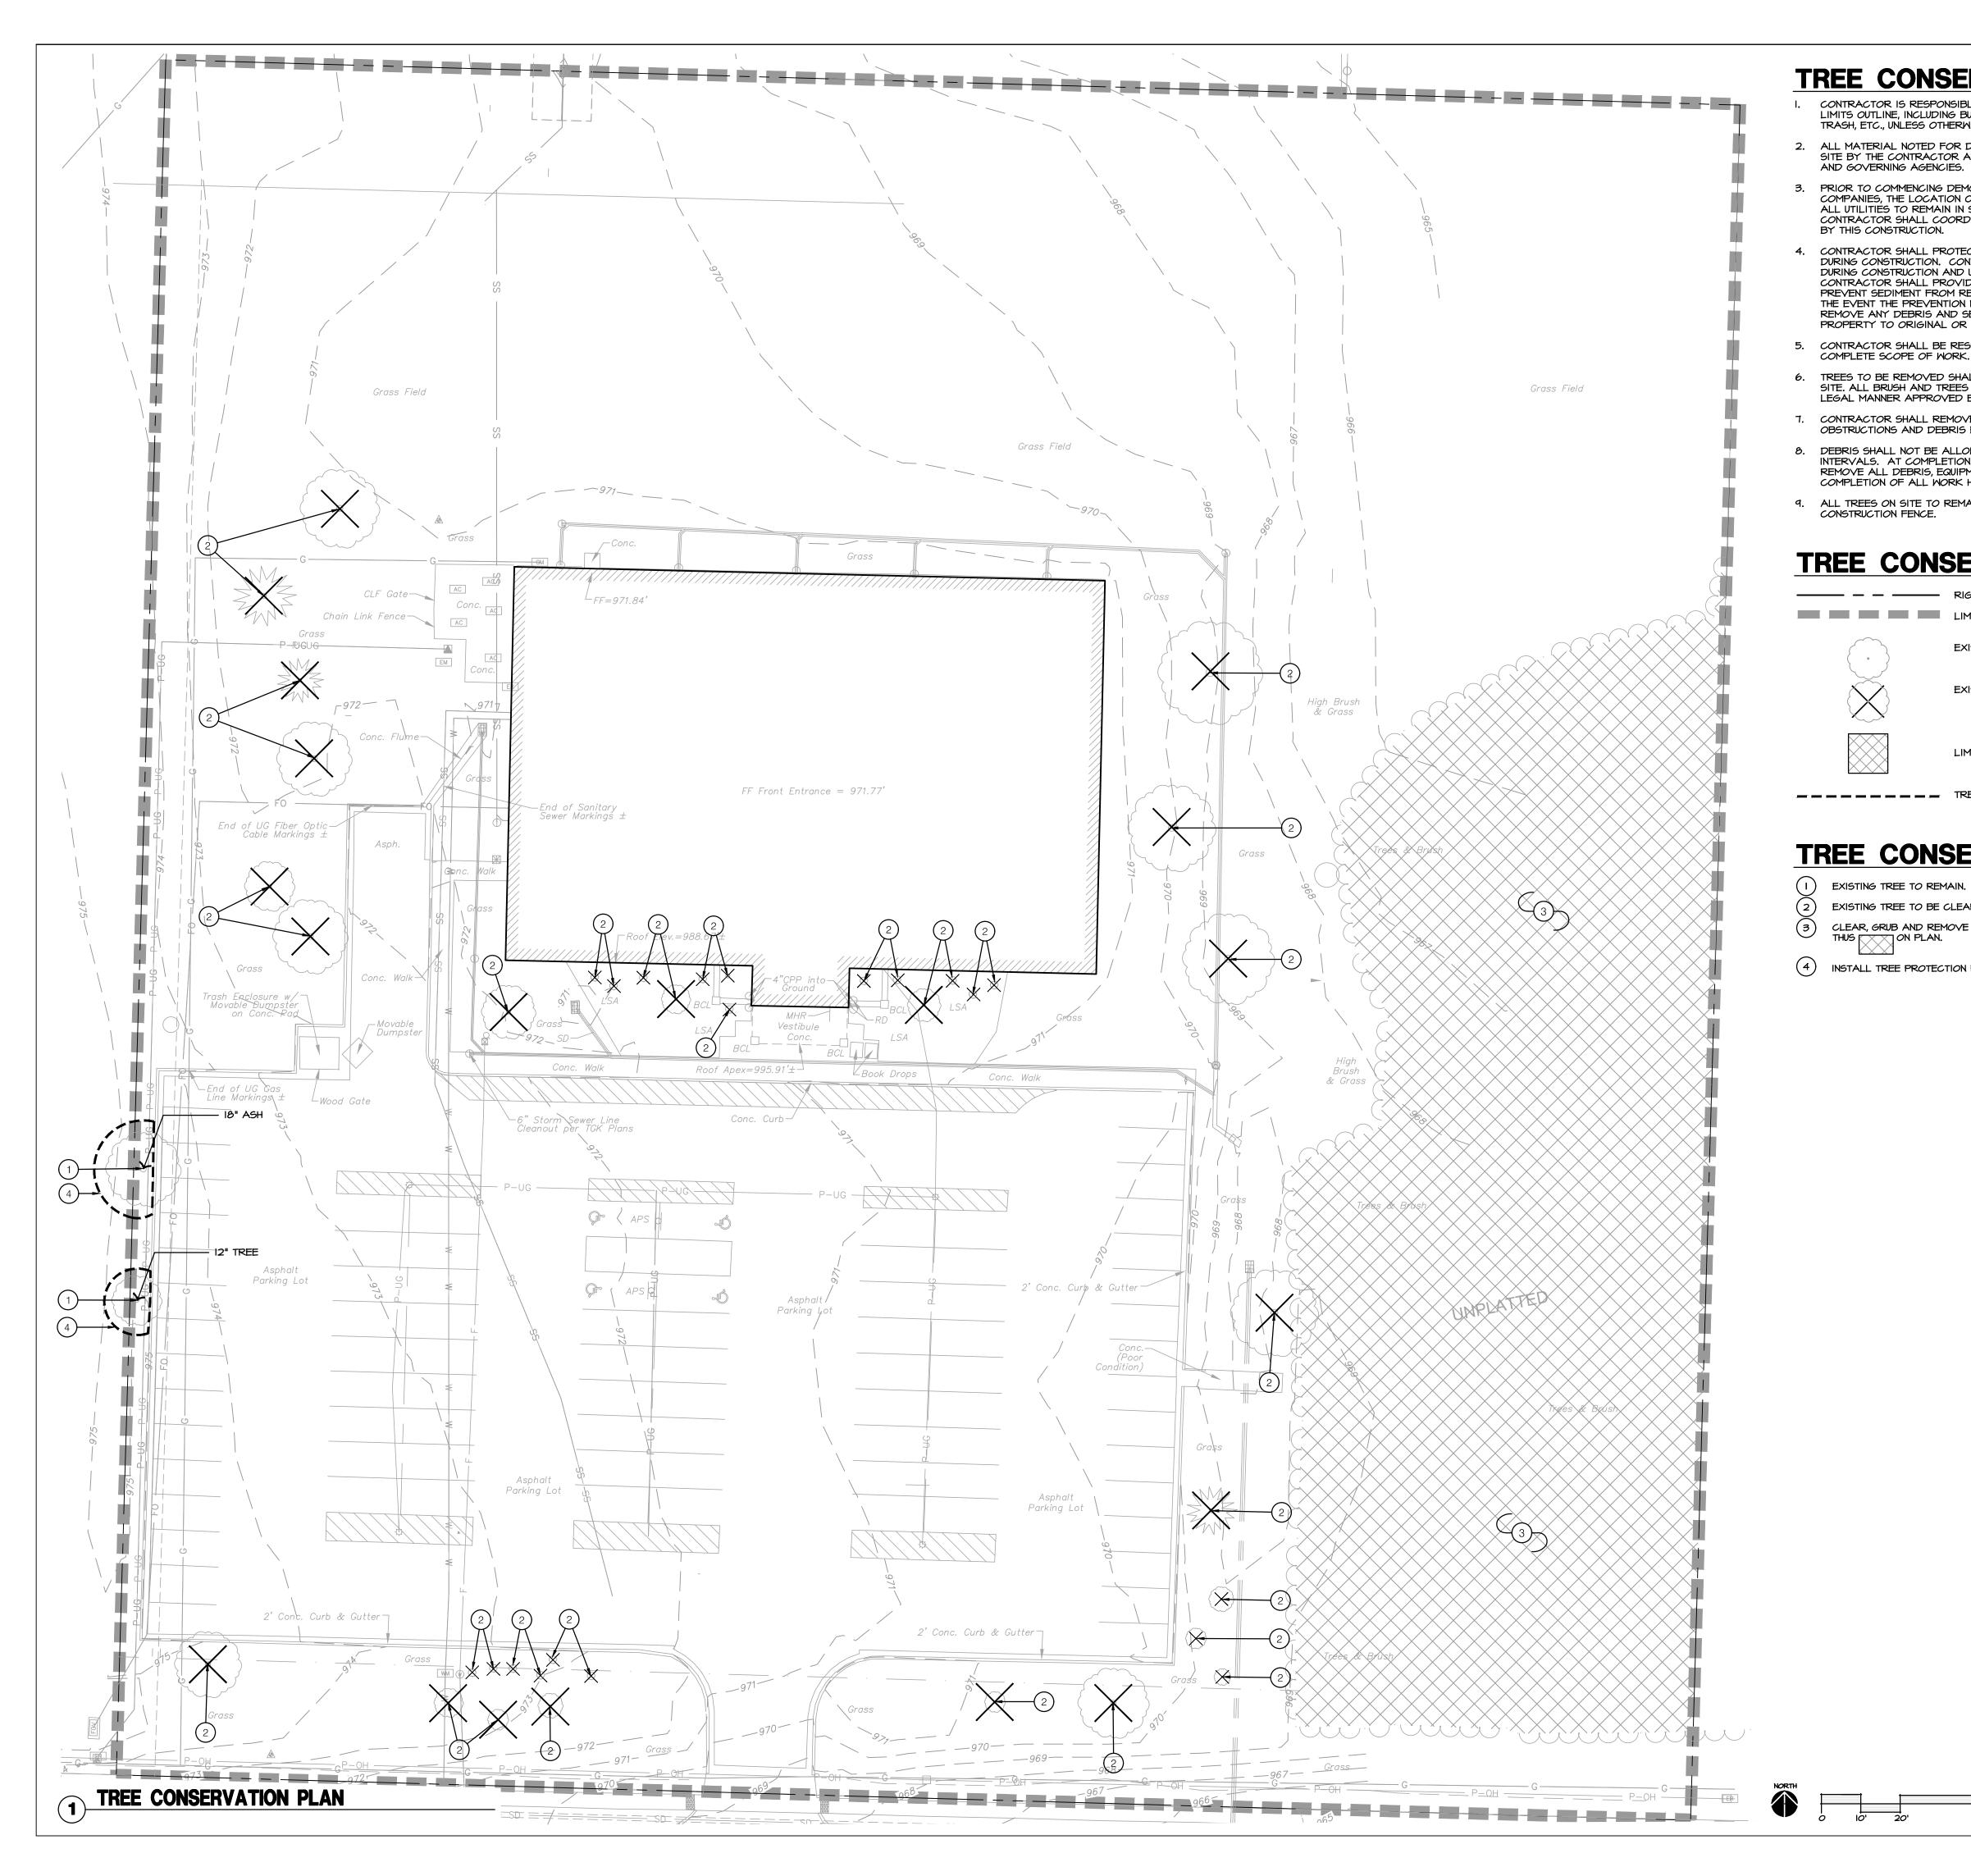

TREE CONSERVATION GENERAL NOTES:

CONTRACTOR IS RESPONSIBLE FOR THE DEMOLITION OF EXISTING FEATURES WITHIN THE LIMITS OUTLINE, INCLUDING BUT NOT LIMITED TO TREES, UNDERSTORY BRUSH, TURF LAWN, TRASH, ETC., UNLESS OTHERWISE NOTED.

ALL MATERIAL NOTED FOR DEMOLITION AND REMOVAL SHALL BE REMOVED, LEGALLY, OFF SITE BY THE CONTRACTOR AND DISPOSED OF AT LOCATIONS ACCEPTABLE TO THE OWNER AND GOVERNING AGENCIES.

PRIOR TO COMMENCING DEMOLITION WORK, THE CONTRACTOR SHALL VERIFY WITH UTILITY COMPANIES, THE LOCATION OF ALL EXISTING UTILITIES. THE CONTRACTOR SHALL PROTECT ALL UTILITIES TO REMAIN IN SERVICE DURING DEMOLITION AND CONSTRUCTION. THE CONTRACTOR SHALL COORDINATE THE RELOCATION OF ANY AND ALL UTILITIES AS REQUIRED

4. CONTRACTOR SHALL PROTECT EXISTING STORM DRAINAGE STRUCTURES FROM SILTATION DURING CONSTRUCTION. CONTRACTOR SHALL PROVIDE FOR CONTROL OF SURFACE EROSION DURING CONSTRUCTION AND UNTIL THE OWNER ACCEPTS THE WORK AS COMPLETE. THE CONTRACTOR SHALL PROVIDE BERMS, SILT FENCE, STRAW BALES OR OTHER MEANS TO PREVENT SEDIMENT FROM REACHING THE PUBLIC RIGHT-OF-WAY, OR ADJACENT PROPERTY. IN THE EVENT THE PREVENTION MEASURES ARE NOT EFFECTIVE, THE CONTRACTOR SHALL REMOVE ANY DEBRIS AND SEDIMENT AND RESTORE THE RIGHT-OF-WAY AND ADJACENT PROPERTY TO ORIGINAL OR BETTER CONDITION.

5. CONTRACTOR SHALL BE RESPONSIBLE FOR ACQUIRING ALL REQUIRED PERMITS TO COMPLETE SCOPE OF WORK.

TREES TO BE REMOVED SHALL BE CUT DOWN, DEMOLISHED AND REMOVED FROM THE SITE. ALL BRUSH AND TREES SHALL BE REMOVED FROM THE SITE AND DISPOSED OF IN A LEGAL MANNER APPROVED BY OWNER.

7. CONTRACTOR SHALL REMOVE STUMPS BY GRINDING STUMPS AND REMOVING ROOTS, OBSTRUCTIONS AND DEBRIS EXTENDING TO A DEPTH OF 18" BELOW EXPOSED SUBGRADE.

DEBRIS SHALL NOT BE ALLOWED TO ACCUMULATE AND SHALL BE REMOVED AT FREQUENT INTERVALS. AT COMPLETION OF WORK IN EACH AREA, THE CONTRACTOR SHALL GATHER AND REMOVE ALL DEBRIS, EQUIPMENT, AND EXCESS MATERIAL FROM THAT AREA. AT FINAL COMPLETION OF ALL WORK HE SHALL REMOVE ALL SUCH ITEMS FROM THE PREMISES. 9. ALL TREES ON SITE TO REMAIN SHALL BE PROTECTED WITH SILT FENCE AND ORANGE

TREE CONSERVATION LEGEND:

	RIGHT OF WAY / PROPERTY LINE
_	LIMITS OF CONSTRUCTION
}	EXISTING TREE TO REMAIN
	EXISTING TREE & SHRUB TO BE REMOVED
	LIMITS OF EXISTING TREE CANOPY REMOVA

TREE CONSERVATION PLAN NOTES:

EXISTING TREE TO BE CLEAR, GRUBBED, AND REMOVED.

CLEAR, GRUB AND REMOVE EXISTING TREE CANOPY TO LIMITS INDICATED AS

(4) INSTALL TREE PROTECTION FENCE; REF: 2/LIOO



Sapp Design Associates Architects, P.C. Missouri State Certificate of Authority #000607




1629 Walnut Kansas City, MO 64108


816.300.0300

SPECIAL NOTICES

In the event the client consents to, allows, authorizes or approves of changes to any plans, specifications or other construction documents, and these changes are not approved in writing by the design professional, the client recognizes that such changes and the results thereof are not the responsibility of the design professional. Therefore, the client agrees to release the design professional from any liability arising from the construction, use or result of such changes. In addition, the client agrees to the fullest extent permitted by law, to indemnify and hold the design professional harmless from any damage, liability or cost (including reasonable attorney's fees and costs of defense) arising from such changes. \sim

The personal seal of the registered Architect or Engineer shall be the legal equivalent of his signature whenever & wherever used, and the owner of the seal shall authenticate this sheet and the specification sections pertaining to this sheet. Responsibility shall be disclaimed for all other plans, specifications, estimates, reports or other documents or instruments relating to or intended to be used for any part or parts of the architectural project.

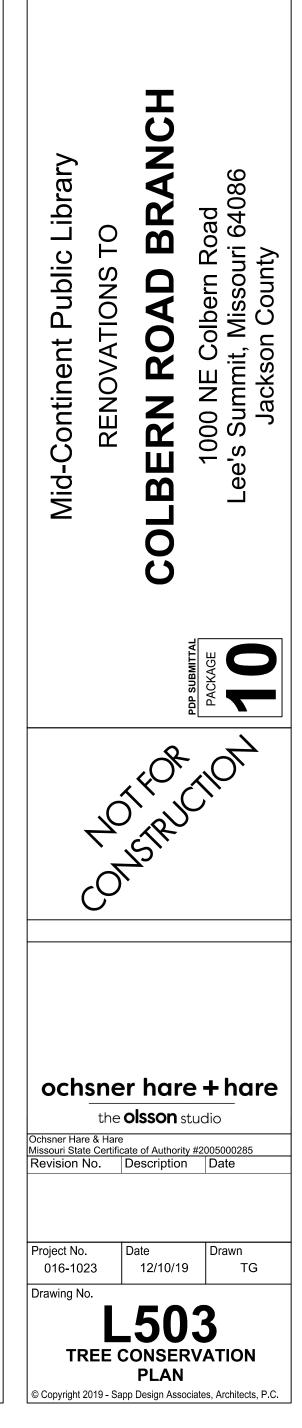

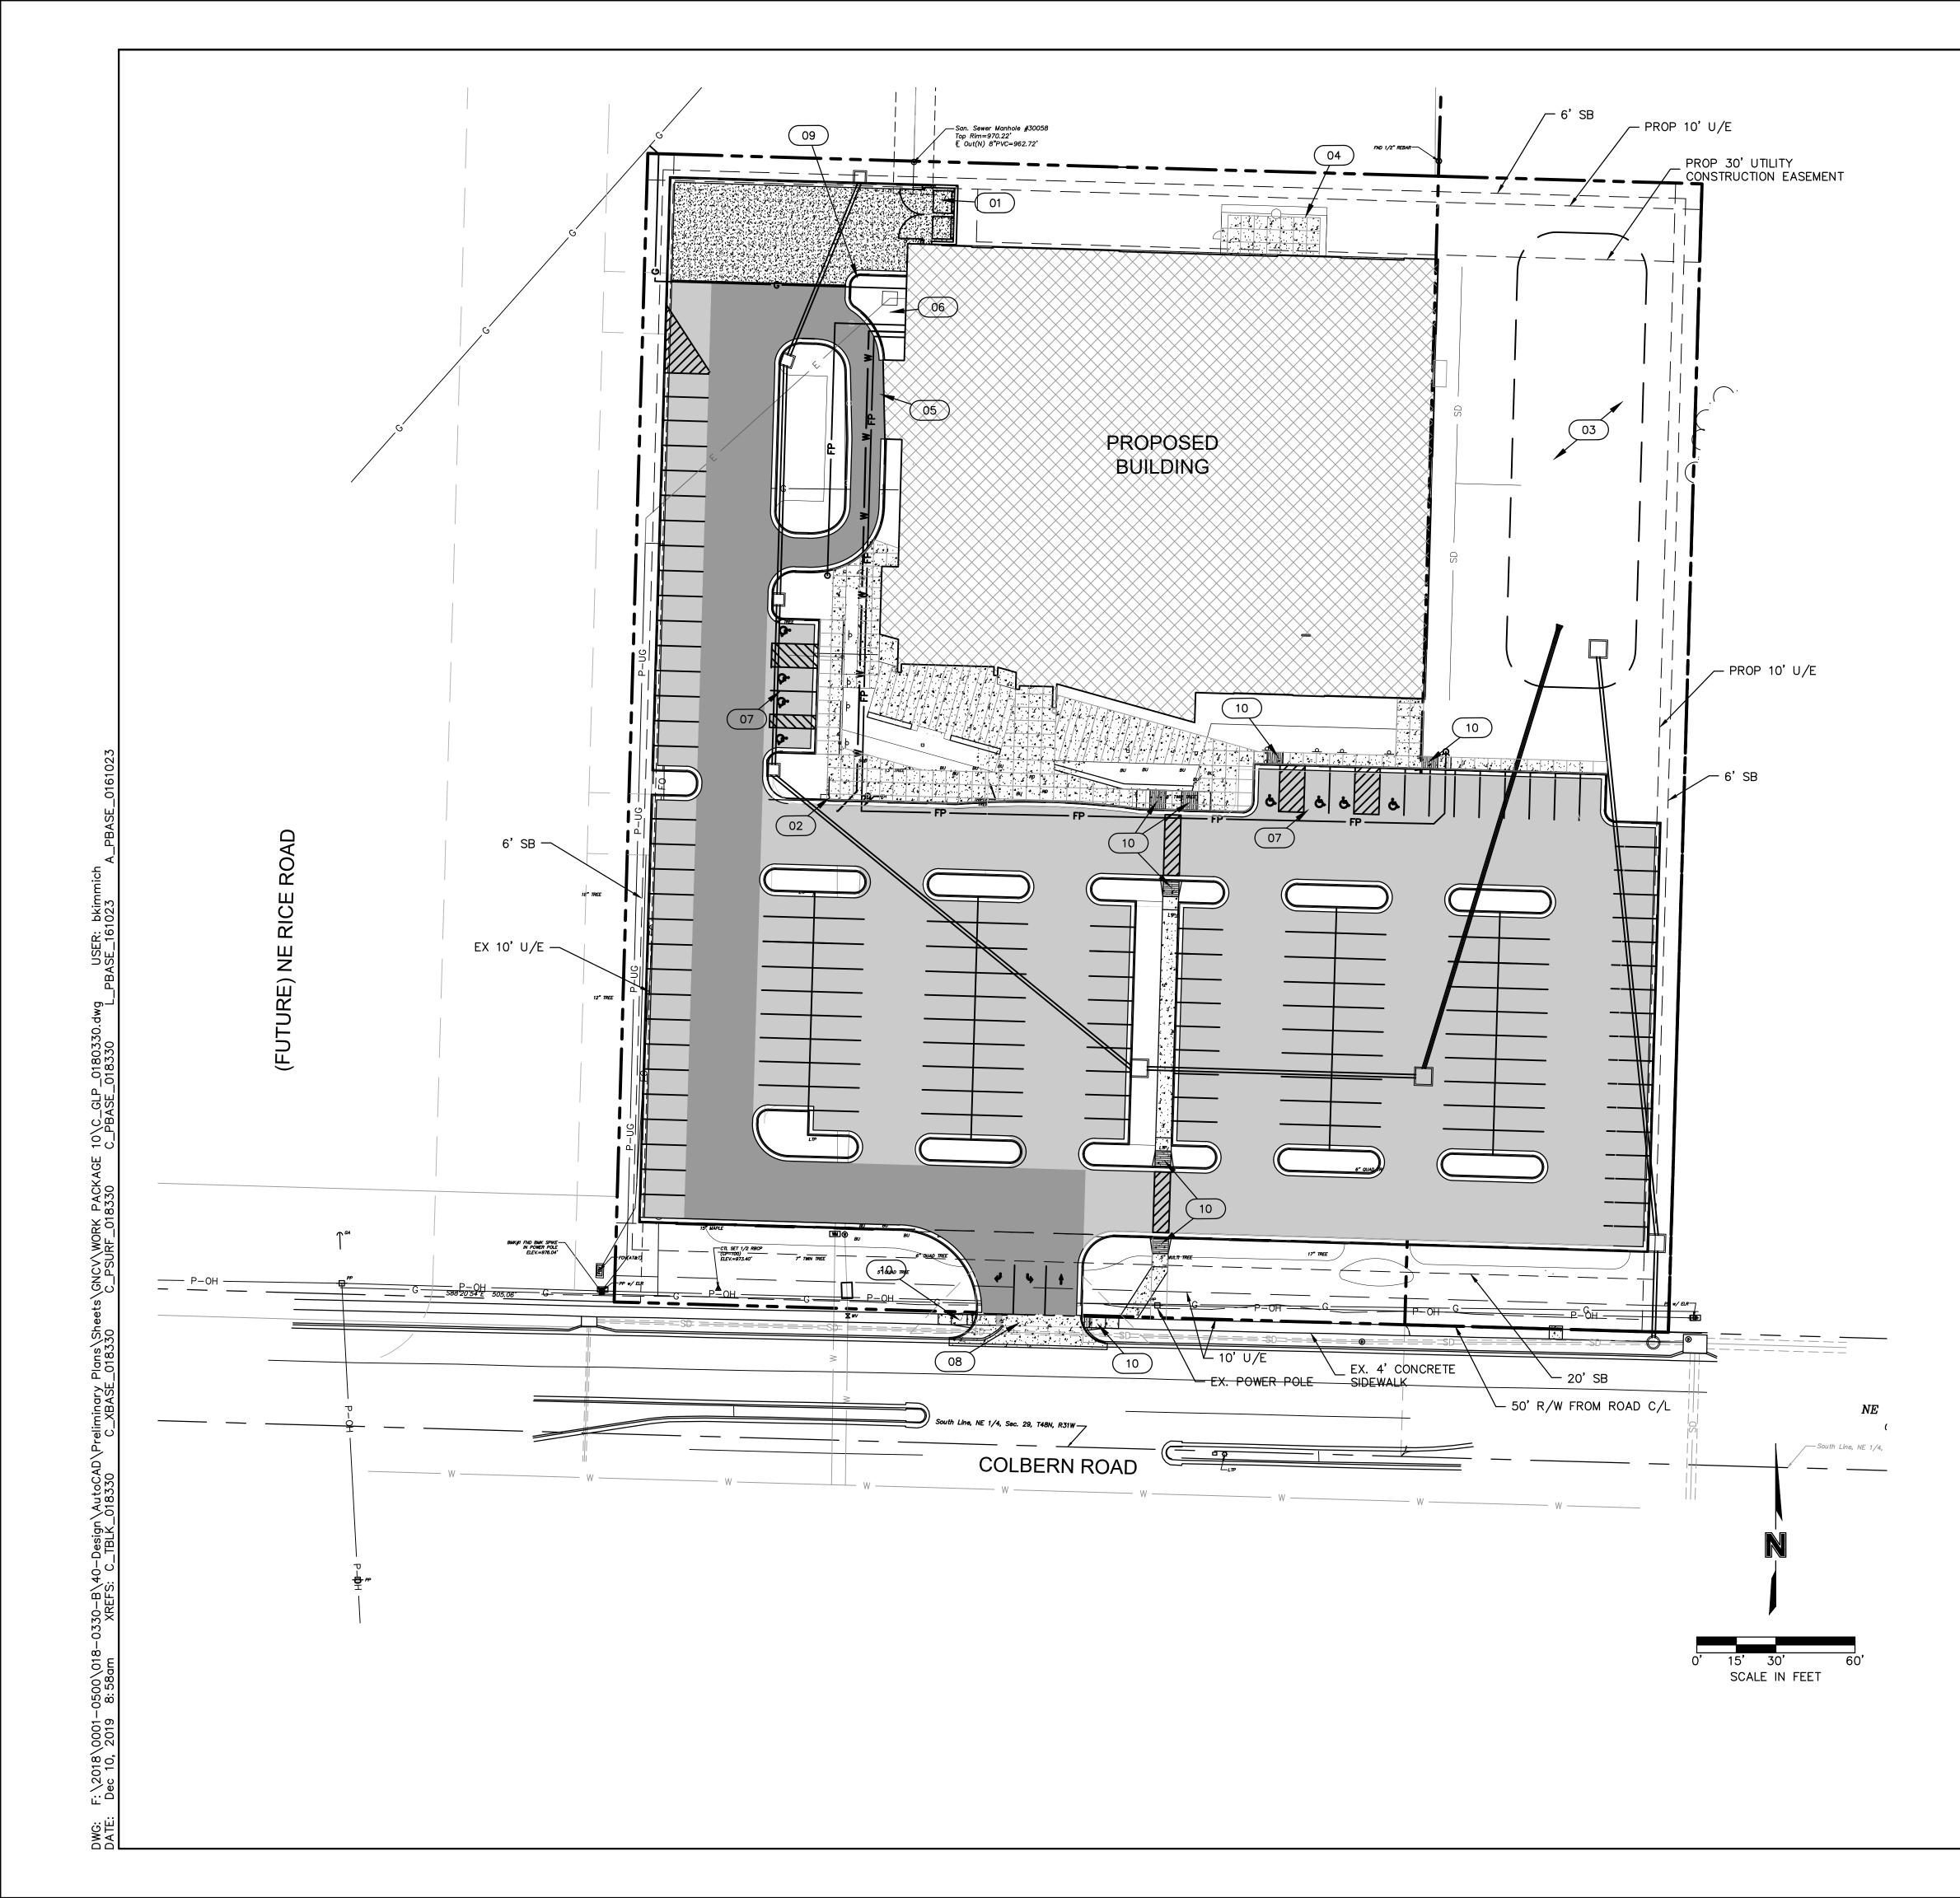

SITE DATA				
ZONING & SITE AREA				
PROPOSED USE:	PUBLIC LIBRARY	(
SITE AREA			ZONING	
LOT 2 (AS DECRIBED):	4.00 ACRES (17	74,237 SF))	CP-2
IMPERVIOUS:	2.58 ACRES (11	2,384 SF)	(64%)	
PERVIOUS:	1.42 ACRES (61	,855 SF)	(36%)	
FAR (0.55 MAX):	0.15			
BUILDING AREA				
BUILDING TYPE	# STORIES	SQL	JARE F	OOTAGE
BUILDING	1		34,03	0 SF
PARKING				
USE	REQUIRE	ED	P	ROVIDED
LIBRARY	4 PER 1000 SF	= 136	163	
ADA	4 (PER CITY TA	BLE)	8	
TOTAL	136		166 (II	NCLUDING ADA)

NOTE:

ACCORDING TO MDNR STATE OIL & GAS COUNSEL THERE ARE NO OIL AND GAS WELLS LOCATED WITHIN OR ADJACENT TO THE PROPERTY.

THERE ARE NO FEMA DELINEATED FLOODPLAINS ON THE PROPERTY.

	LEGEND
	PROPERTY LINES
	RIGHT-OF-WAY LINES
	LOT LINES
	ROAD CENTERLINE
	EASEMENT LINES
· ·	SETBACK LINES
851	EXISTING GRADE CONTOURS
851	PROPOSED GRADE CONTOURS
Р-ОН	
P-UG	UNDERGROUND ELECTRIC
TEL	UNDERGROUND TELEPHONE
FO	UNDERGROUND FIBER OPTIC
G	GAS LINE
W	WATER LINE
FP	FIRE PROTECTION LINE
<u> </u>	STORM SEWER LINE
SS	SANITARY SEWER LINE
	ACCESSIBLE SIDEWALK RAMP
	CONCRETE CURB & GUTTER
IIIIIIII	TYPE "B" RE: DETAILS
-	CONCRETE CURB & GUTTER
	TYPE "B-DRY" RE: DETAILS
	PROPOSED CONCRETE SIDEWALK
	PROPOSED HEAVY DUTY CONCRETE PAVEMENT
<u>~~~~~~~~~~~~</u> ~~~~~~~~~~~~~~~~~~~~~~~~	
	PROPOSED LIGHT DUTY ASPHALT
	PROPOSED HEAVY DUTY ASPHALT
	PROPOSED DETENTION BASIN

KEYNOTES: XX

01 TRASH ENCLOSURE - CMU WALLS WITH BRICK FACING AND STEEL DOORS
 02 BOOK DROP


- 03 EXTEND DRY DETENTION BASIN
- 04 CONCRETE PATIO
- 05 DRIVE-THRU WINDOW
- 06 POWER TRANSFORMER
- 07 ADA ACCESSIBLE SIGNAGE AND STRIPING
- 08 WIDENED COMMERCIAL ENTRANCE (40') WITH RECONSTRUCTED ADA RAMP
- 09 REMOTE FIRE DEPARTMENT CONNECTION
- 10 ADA RAMP PER CITY DETAILS

LEGAL DESCRIPTION

ALL OF LOT 1, RICE ACRES, A SUBDIVISION IN THE CITY OF LEE'S SUMMIT, JACKSONCOUNTY,MISSOURI, TOGETHER WITH ALL THAT PART OF AN UNPLATTED TRAC T OF LAND, ALL LYING IN THE NORTHEAST QUARTER OF SECTION 29, TOWNSHIP 48 NORTH, RANGE 31 WEST, DESCRIBED BY TIMOTHY BLAIR WISWELL, MO-PLS 2009000067, AS FOLLOWS:


COMMENCING AT THE SOUTHEAST CORNER OF THE NORTHEAST QUARTER OF SECTION 29, TOWNSHIP 48 NORTH, RANGE 31 WEST; THENCE NORTH 88 DEGREES 28 MINUTES 52 SECONDS WEST, ON THE SOUTH LINE OF SAID NORTHEAST QUARTER, A DISTANCE OF 755.18 FEET TO A POINT ON THE SOUTHERLY EXTENSION OF THE WEST LINE OF LOT 1, RICE ACRES, A SUBDIVISION IN THE CITY OF LEE'S SUMMIT, JACKSON COUNTY, MISSOURI; THENCE NORTH 01 DEGREE 23 MINUTES 04 SECONDS EAST, DEPARTING SAID SOUTH LINE, ON SAID SOUTHERLY EXTENSION, A DISTANCE OF 55.66 FEET TO THE SOUTHWEST CORNER OF SAID LOT 1, THE POINT OF BEGINNING; THENCE NORTH 01 DEGREE 23 MINUTES 04 SECONDS EAST, ON SAID WEST LINE, A DISTANCE OF 436.21 FEET TO THE NORTHWEST CORNER OF SAID LOT 1; THENCE SOUTH 88 DEGREES 38 MINUTES 41 SECONDS EAST, ON THE NORTH LINE OF SAID LOT 1 AND ITS EASTERLY EXTENSION, A DISTANCE OF 400.00 FEET TO A POINT; THENCE SOUTH 01 DEGREE 23 MINUTES 04 SECONDS WEST, DEPARTING SAID EASTERLY EXTENSION, A DISTANCE OF 436.21 FEET TO A POINT ON THE EASTERLY EXTENSION OF THE SOUTH LINE OF SAID LOT 1; THENCE NORTH 88 DEGREES 38 MINUTES 41 SECONDS WEST, ON SAID EASTERLY EXTENSION AND ON SAID SOUTH LINE, A DISTANCE OF 400.00 FEET TO THE POINT OF BEGINNING, CONTAINING 174,485 SQUARE FEET OR 4.0056 ACRES, MORE OR LESS.

СЛОГ	
SAP	C N
ARCHIT	ECTS
3750 S. Fremont Ave. Springfield, MO 65804 Sapp Design Associates Archite	417.877.9600 ects, P.C.
Missouri State Certificate of Au	
1629 Walnut Kansas City, MO 64108	816.300.0300
SPECIAL NOT In the event the client consents to, allows, au changes to any plans, specifications or other documents, and these changes are not appre- design professional, the client recognizes tha results thereof are not the responsibility of the Therefore, the client agrees to release the de any liability arising from the construction, use changes. In addition, the client agrees to the by law, to indemnify and hold the design prof- any damage, liability or cost (including reasou- costs of defense) arising from such changes. The personal seal of the registered Architect legal equivalent of his signature whenever & owner of the seal shall authenticate this shee sections pertaining to this sheet. Responsibi for all other plans, specifications, estimates, in documents or instruments relating to or inten- part or parts of the architectural project.	thorizes or approves of construction oved in writing by the t such changes and the e design professional sign professional from or result of such fullest extent permitted essional harmless from nable attorney's fees and or Engineer shall be the wherever used, and the t and the specification lity shall be disclaimed eports or other
Mid-Continent Public Library PRELIMINARY DEVELOPMENT PLANS FOR COLBERN ROAD BRANCH	Packade 1000 N.E. COLBERN ROAD LEE'S SUMMIT, MO 64086 JACKSON COUNTY
PRELIMINA DEVELOPMEN	RY
NOT FOR CONST	
Terry M Parsons, Engineer MC	
olsso	n
7301 West 133rd Street, Suite Overland Park, KS 66213 TEL 913.381.1170 FAX 913.381.1174 www.olssonassociates.com Olsson Missouri State Certificate of A Revision No. Description	
Project No. Date B18-0330 09-18-18 Drawing No.	Drawn KDP
GENERAL LAYO	

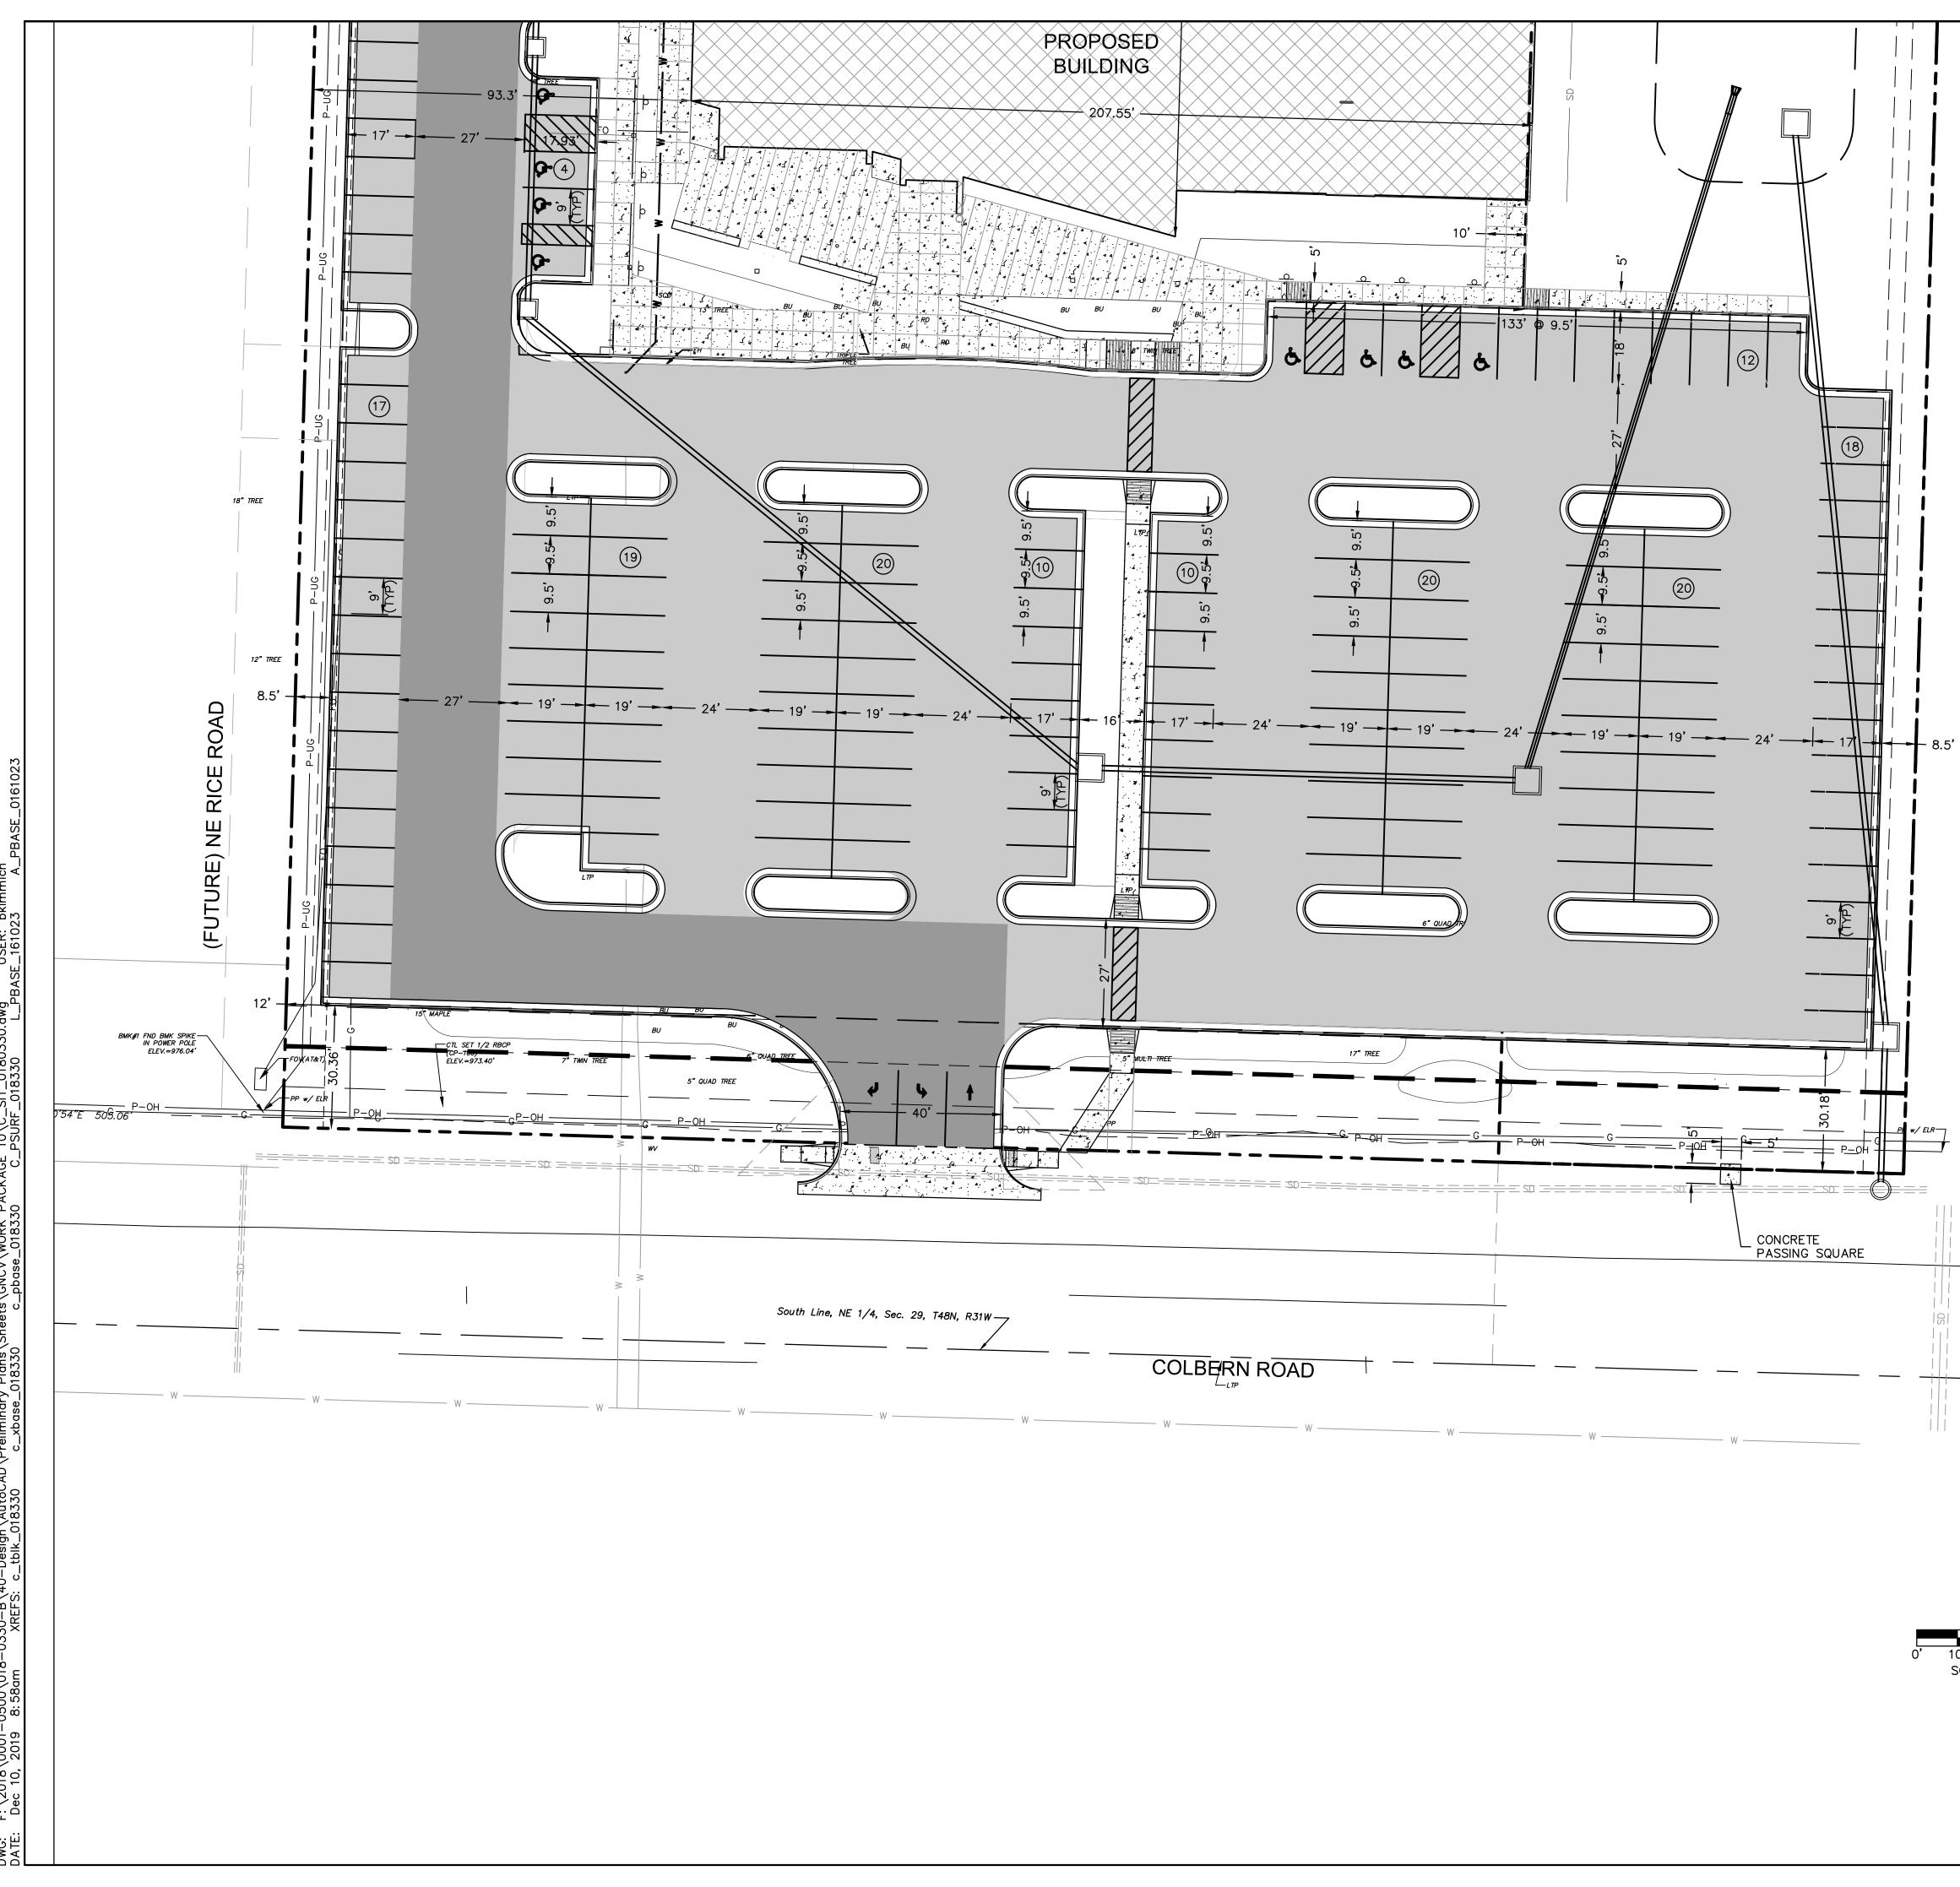


_SIT_0180; _018330 10\C_ _PSURF_ 윤이 τÇ Χď <u>∞</u> o

EXISTING CONDITIONS LEGEND

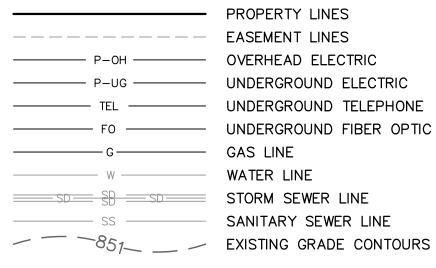

- PROPERTY LINES EASEMENT LINES - P-OH - OVERHEAD ELECTRIC - P-UG ------ UNDERGROUND ELECTRIC UNDERGROUND TELEPHONE ------ UNDERGROUND FIBER OPTIC GAS LINE WATER LINE SANITARY SEWER LINE


PROPOSED COND

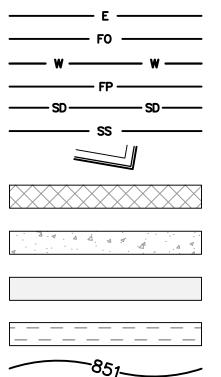

DITIONS LEGEND
PROPOSED UNDERGROUND ELECTRIC
PROPOSED FIBER OPTIC
PROPOSED WATER LINE
PROPOSED FIRE PROTECTION LINE
PROPOSED STORM SEWER LINE
PROPOSED SANITARY SEWER SERVICE
CONCRETE CURB & GUTTER
PROPOSED BUILDING
PROPOSED CONCRETE SIDEWALK
PROPOSED LIGHT DUTY ASPHALT

PROPOSED DETENTION BASIN PROPOSED GRADE CONTOURS

10' 20' SCALE IN FEET

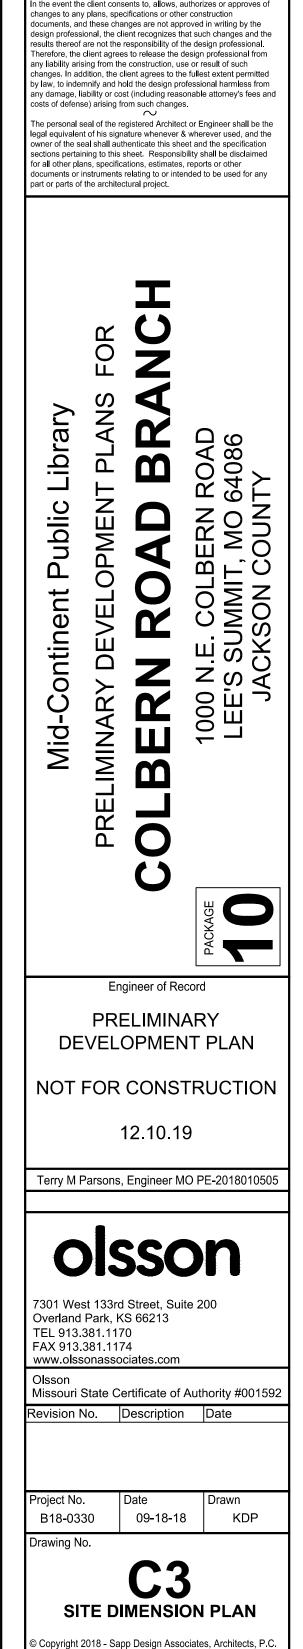

ARCHIT

1629 Walnut Kansas City, MO 64108

Springfield, MO 65804 417.877.9600


Sapp Design Associates Architects, P.C. Missouri State Certificate of Authority #000607

helix.

SPECIAL NOTICES In the event the client consents to, allows, authorizes or approves o

816.300.0300

3750 S. Fremont Ave.

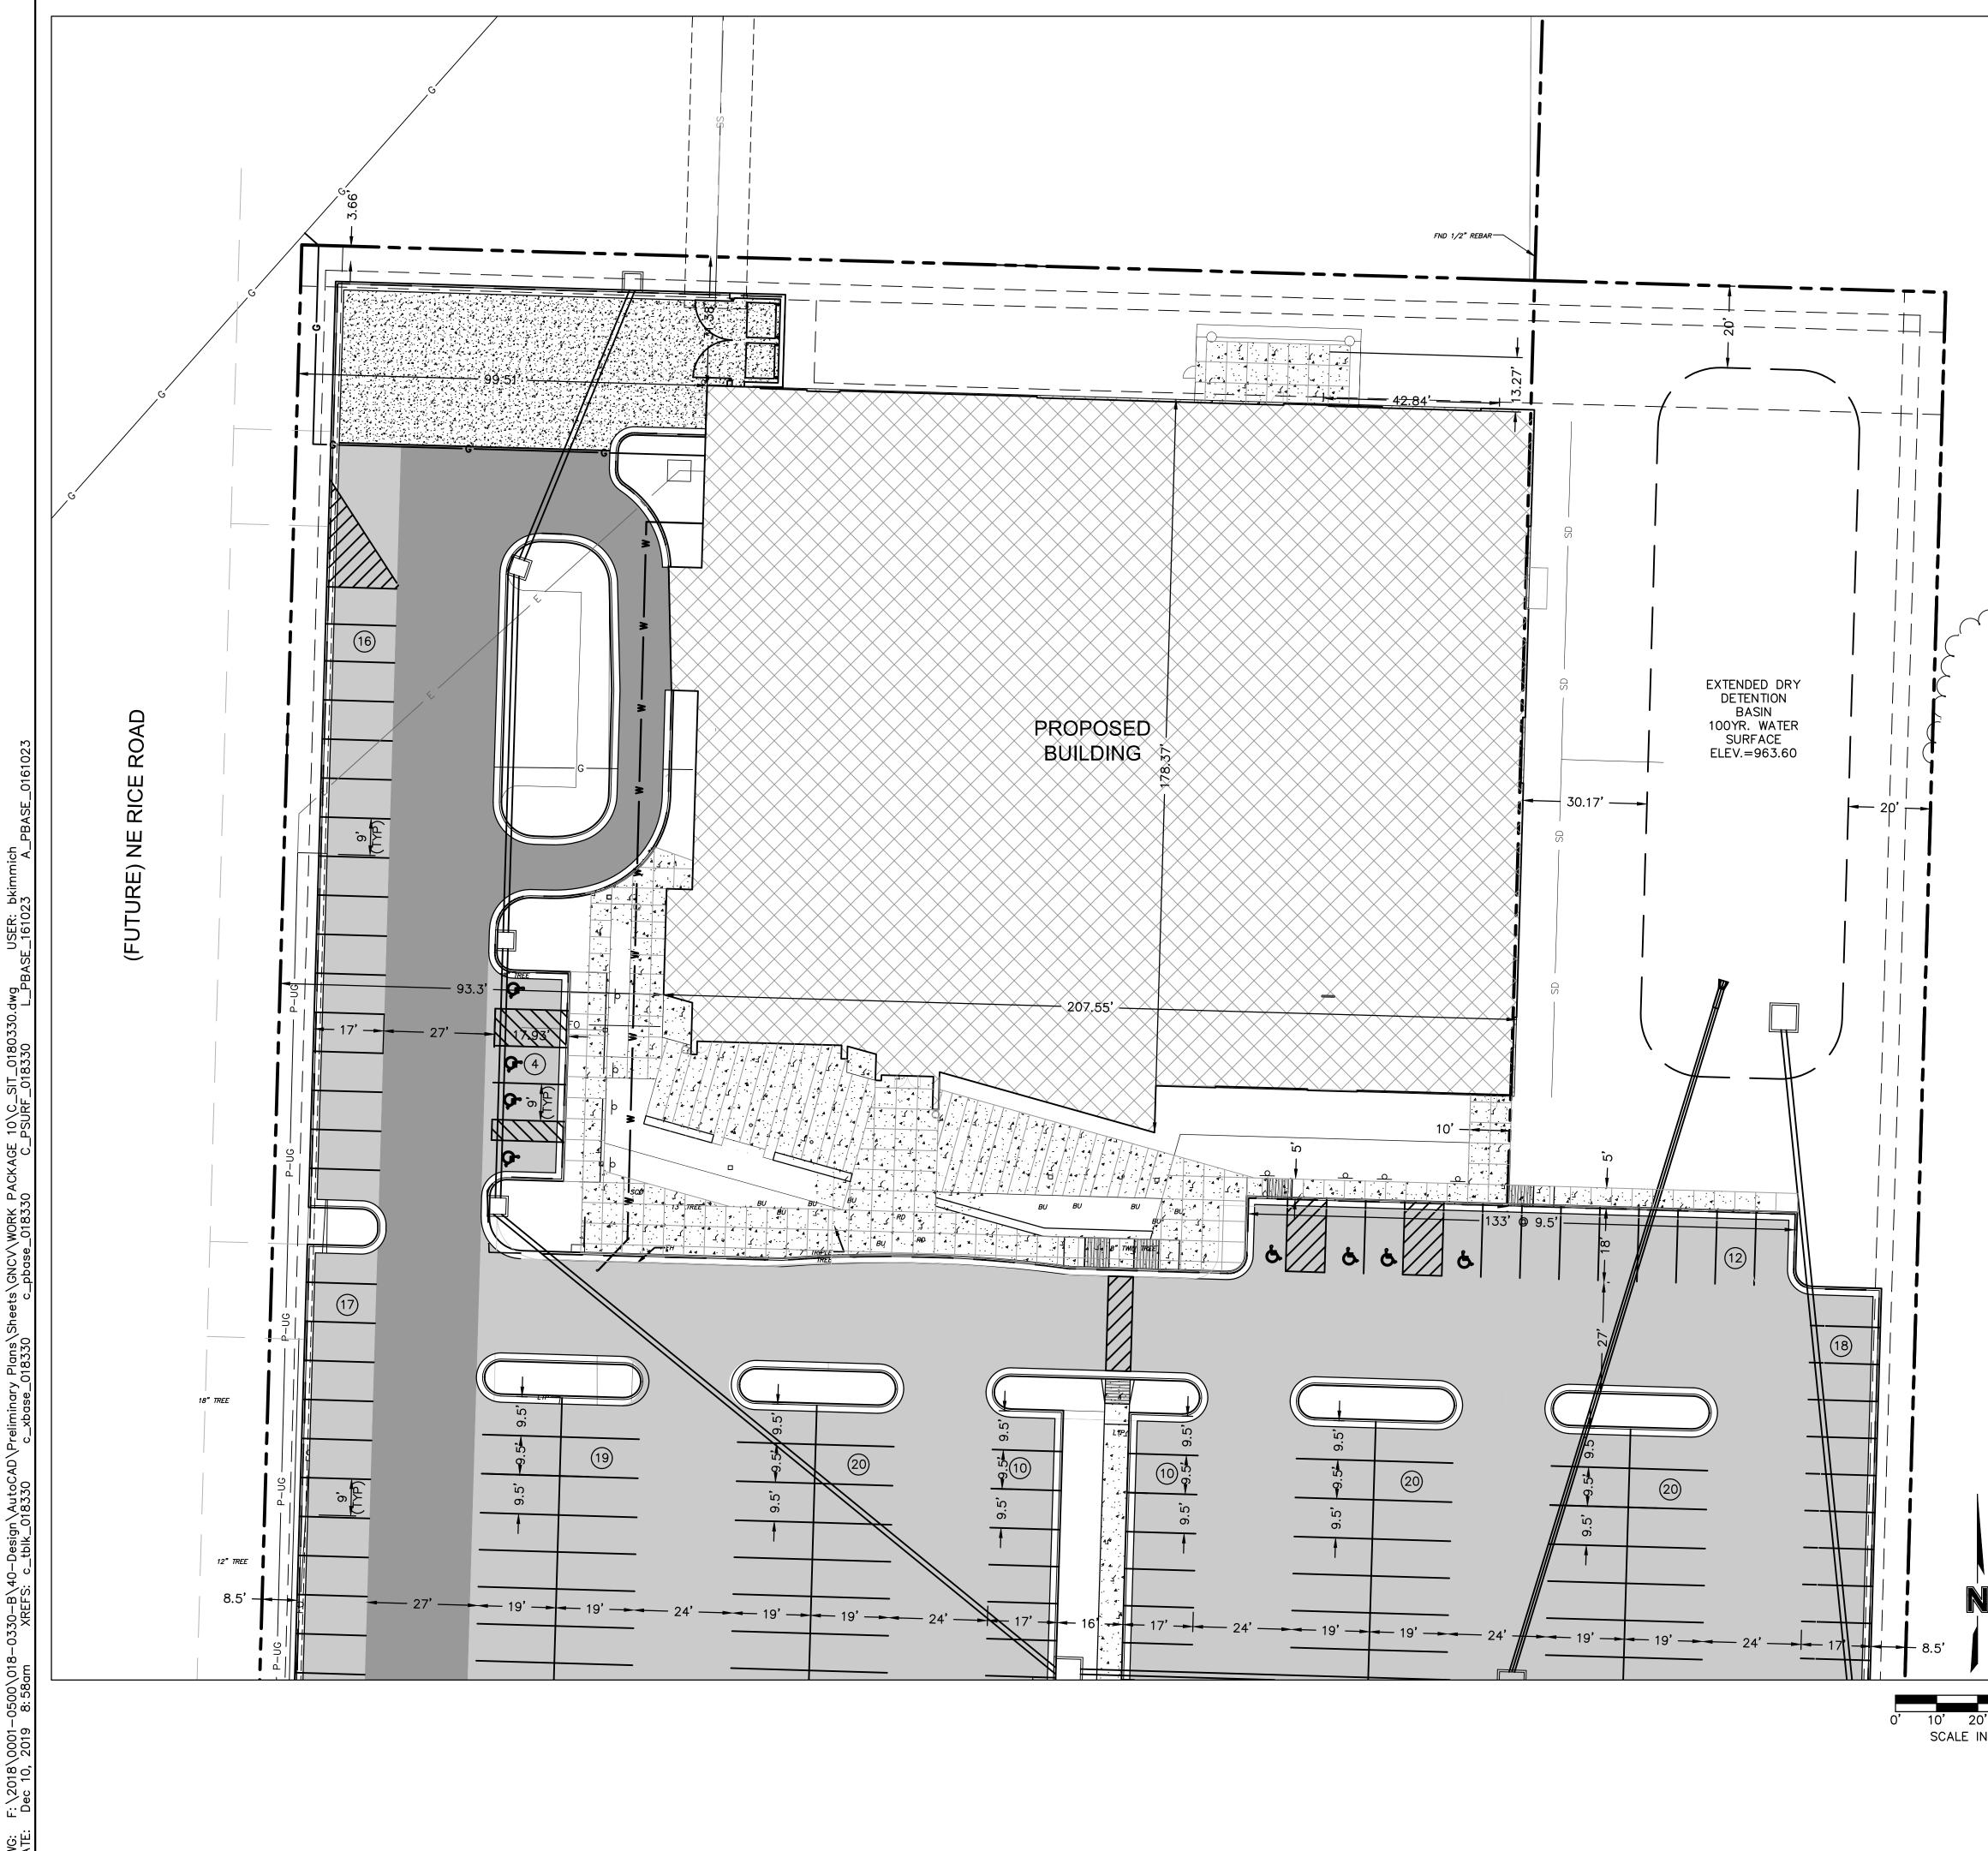


EXISTING CONDITIONS LEGEND

——— Р-ОН ———
P-UG
TEL
———— FO ————
G
W
<u></u>
SS

PROPERTY LINES
 EASEMENT LINES
 OVERHEAD ELECTRIC
 UNDERGROUND ELECTRIC
 UNDERGROUND TELEPHONE
 UNDERGROUND FIBER OPTIC
 GAS LINE
 WATER LINE
 STORM SEWER LINE
 SANITARY SEWER LINE
 EXISTING GRADE CONTOURS


PROPOSED CONDITIONS LEGEND

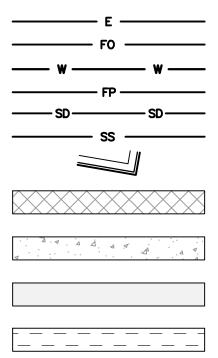


-851-

	UNDERGROUND ELECTRIC
PROPOSED	WATER LINE
PROPOSED	FIRE PROTECTION LINE STORM SEWER LINE SANITARY SEWER SERVICE
	CURB & GUTTER
PROPOSED	BUILDING
PROPOSED	CONCRETE SIDEWALK
PROPOSED	LIGHT DUTY ASPHALT
PROPOSED	DETENTION BASIN

PROPOSED GRADE CONTOURS

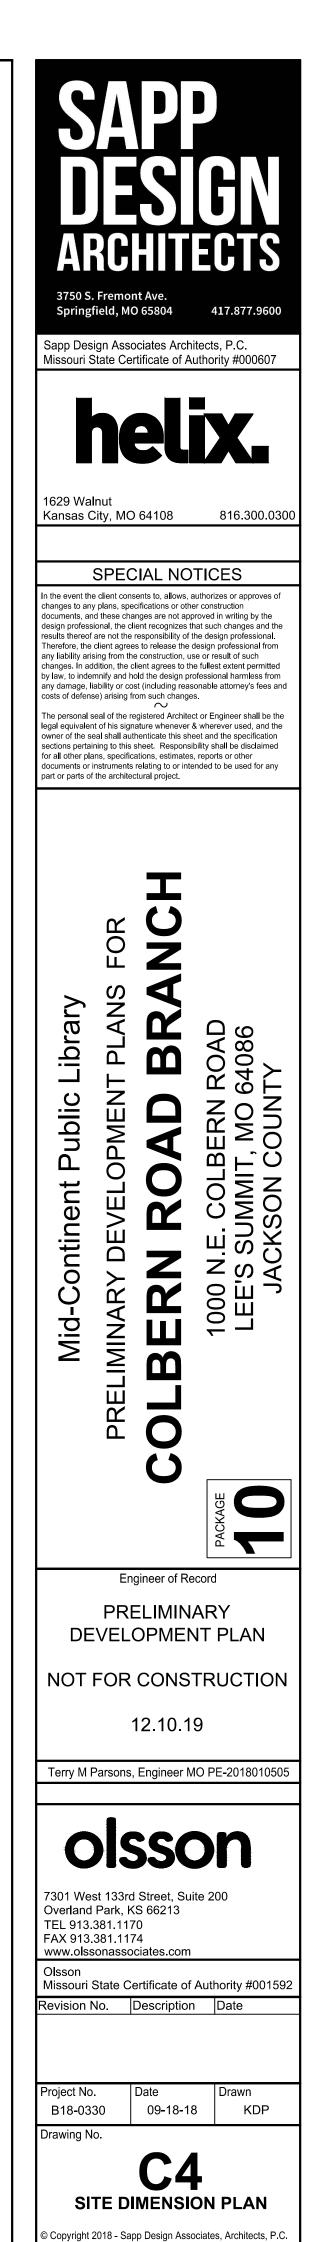

10'20' 40' SCALE IN FEET

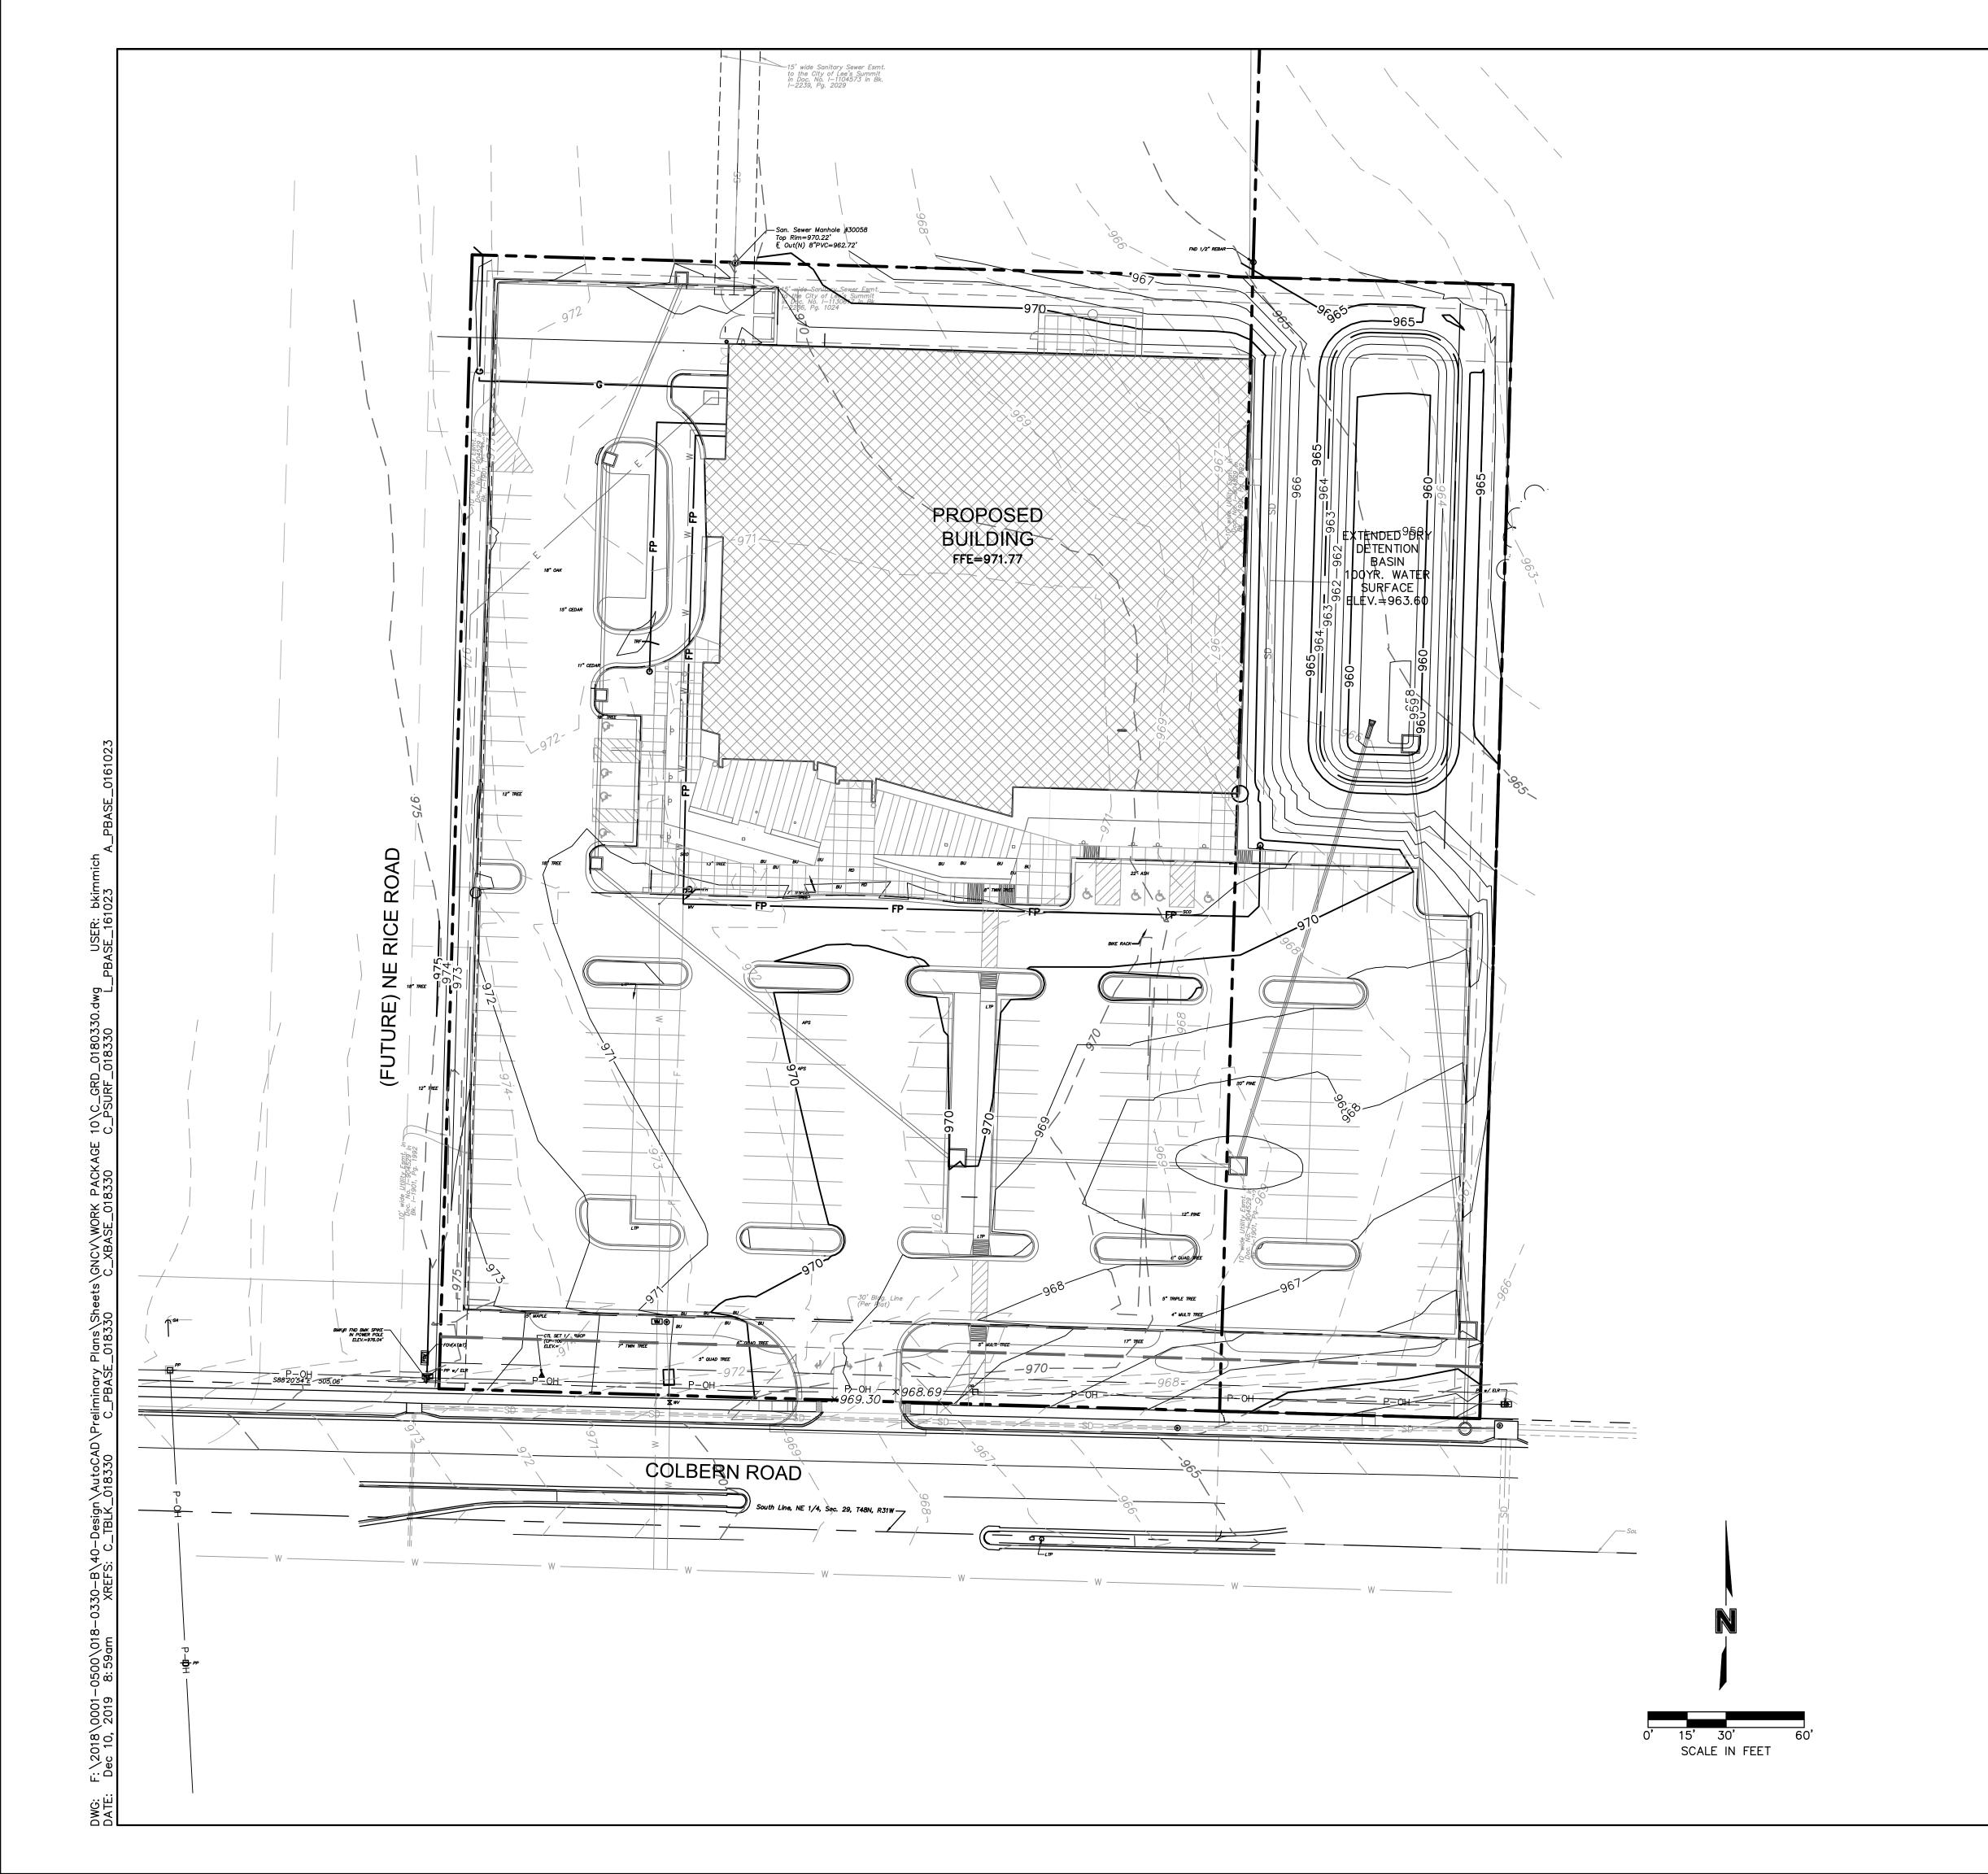

EXISTING CONDITIONS LEGEND

P-OH
P-UG
TEL
FO
G
W
<u>===s</u> D= <u>=</u> =sD= <u>=</u> =
SS

PROPERTY LINES RIGHT-OF-WAY LINES EASEMENT LINES OVERHEAD ELECTRIC UNDERGROUND ELECTRIC UNDERGROUND TELEPHONE UNDERGROUND FIBER OPTIC GAS LINE WATER LINE STORM SEWER LINE SANITARY SEWER LINE

PROPOSED CONDITIONS LEGEND

	— Е —	
	FO	
	— w —	
	FP	
	SD	
	r	
$\wedge \wedge /$		


PROPOSED UNDERGROUND ELECTRIC PROPOSED FIBER OPTIC PROPOSED WATER LINE PROPOSED FIRE PROTECTION LINE PROPOSED STORM SEWER LINE PROPOSED TURF DRAIN LINE PROPOSED SANITARY SEWER SERVICE CONCRETE CURB & GUTTER

PROPOSED BUILDING

ARCHIT 3750 S. Fremont Ave. Springfield, MO 65804 417.877.9600 Sapp Design Associates Architects, P.C. Missouri State Certificate of Authority #000607 helix. 1629 Walnut Kansas City, MO 64108 816.300.0300 SPECIAL NOTICES In the event the client consents to, allows, authorizes or approves of changes to any plans, specifications or other construction documents, and these changes are not approved in writing by the design professional, the client recognizes that such changes and the results thereof are not the responsibility of the design professional. Therefore, the client agrees to release the design professional from any liability arising from the construction, use or result of such changes. In addition, the client agrees to the fullest extent permitted by law, to indemnify and hold the design professional harmless from any damage, liability or cost (including reasonable attorney's fees and costs of defense) arising from such changes. S FOR BRA ANS Library \square 9 08 ٦ \mathbf{O} COUNTY Public OPMEN **AD** 1000 N.E. COLE LEE'S SUMMIT JACKSON (Ο nt ____ DEVE R Mid-Continer COLBERN PRELIMINARY 0 Engineer of Record PRELIMINARY DEVELOPMENT PLAN NOT FOR CONSTRUCTION 12.10.19 Terry M Parsons, Engineer MO PE-2018010505 olsson 7301 West 133rd Street, Suite 200 Overland Park, KS 66213 TEL 913.381.1170 FAX 913.381.1174 www.olssonassociates.com Olsson Missouri State Certificate of Authority #001592 Revision No. Description Date Project No. Drawn KDP B18-0330 09-18-18 Drawing No. **C5**

GRADING PLAN

opyright 2018 - Sapp Design Associates, Architects, P.C.

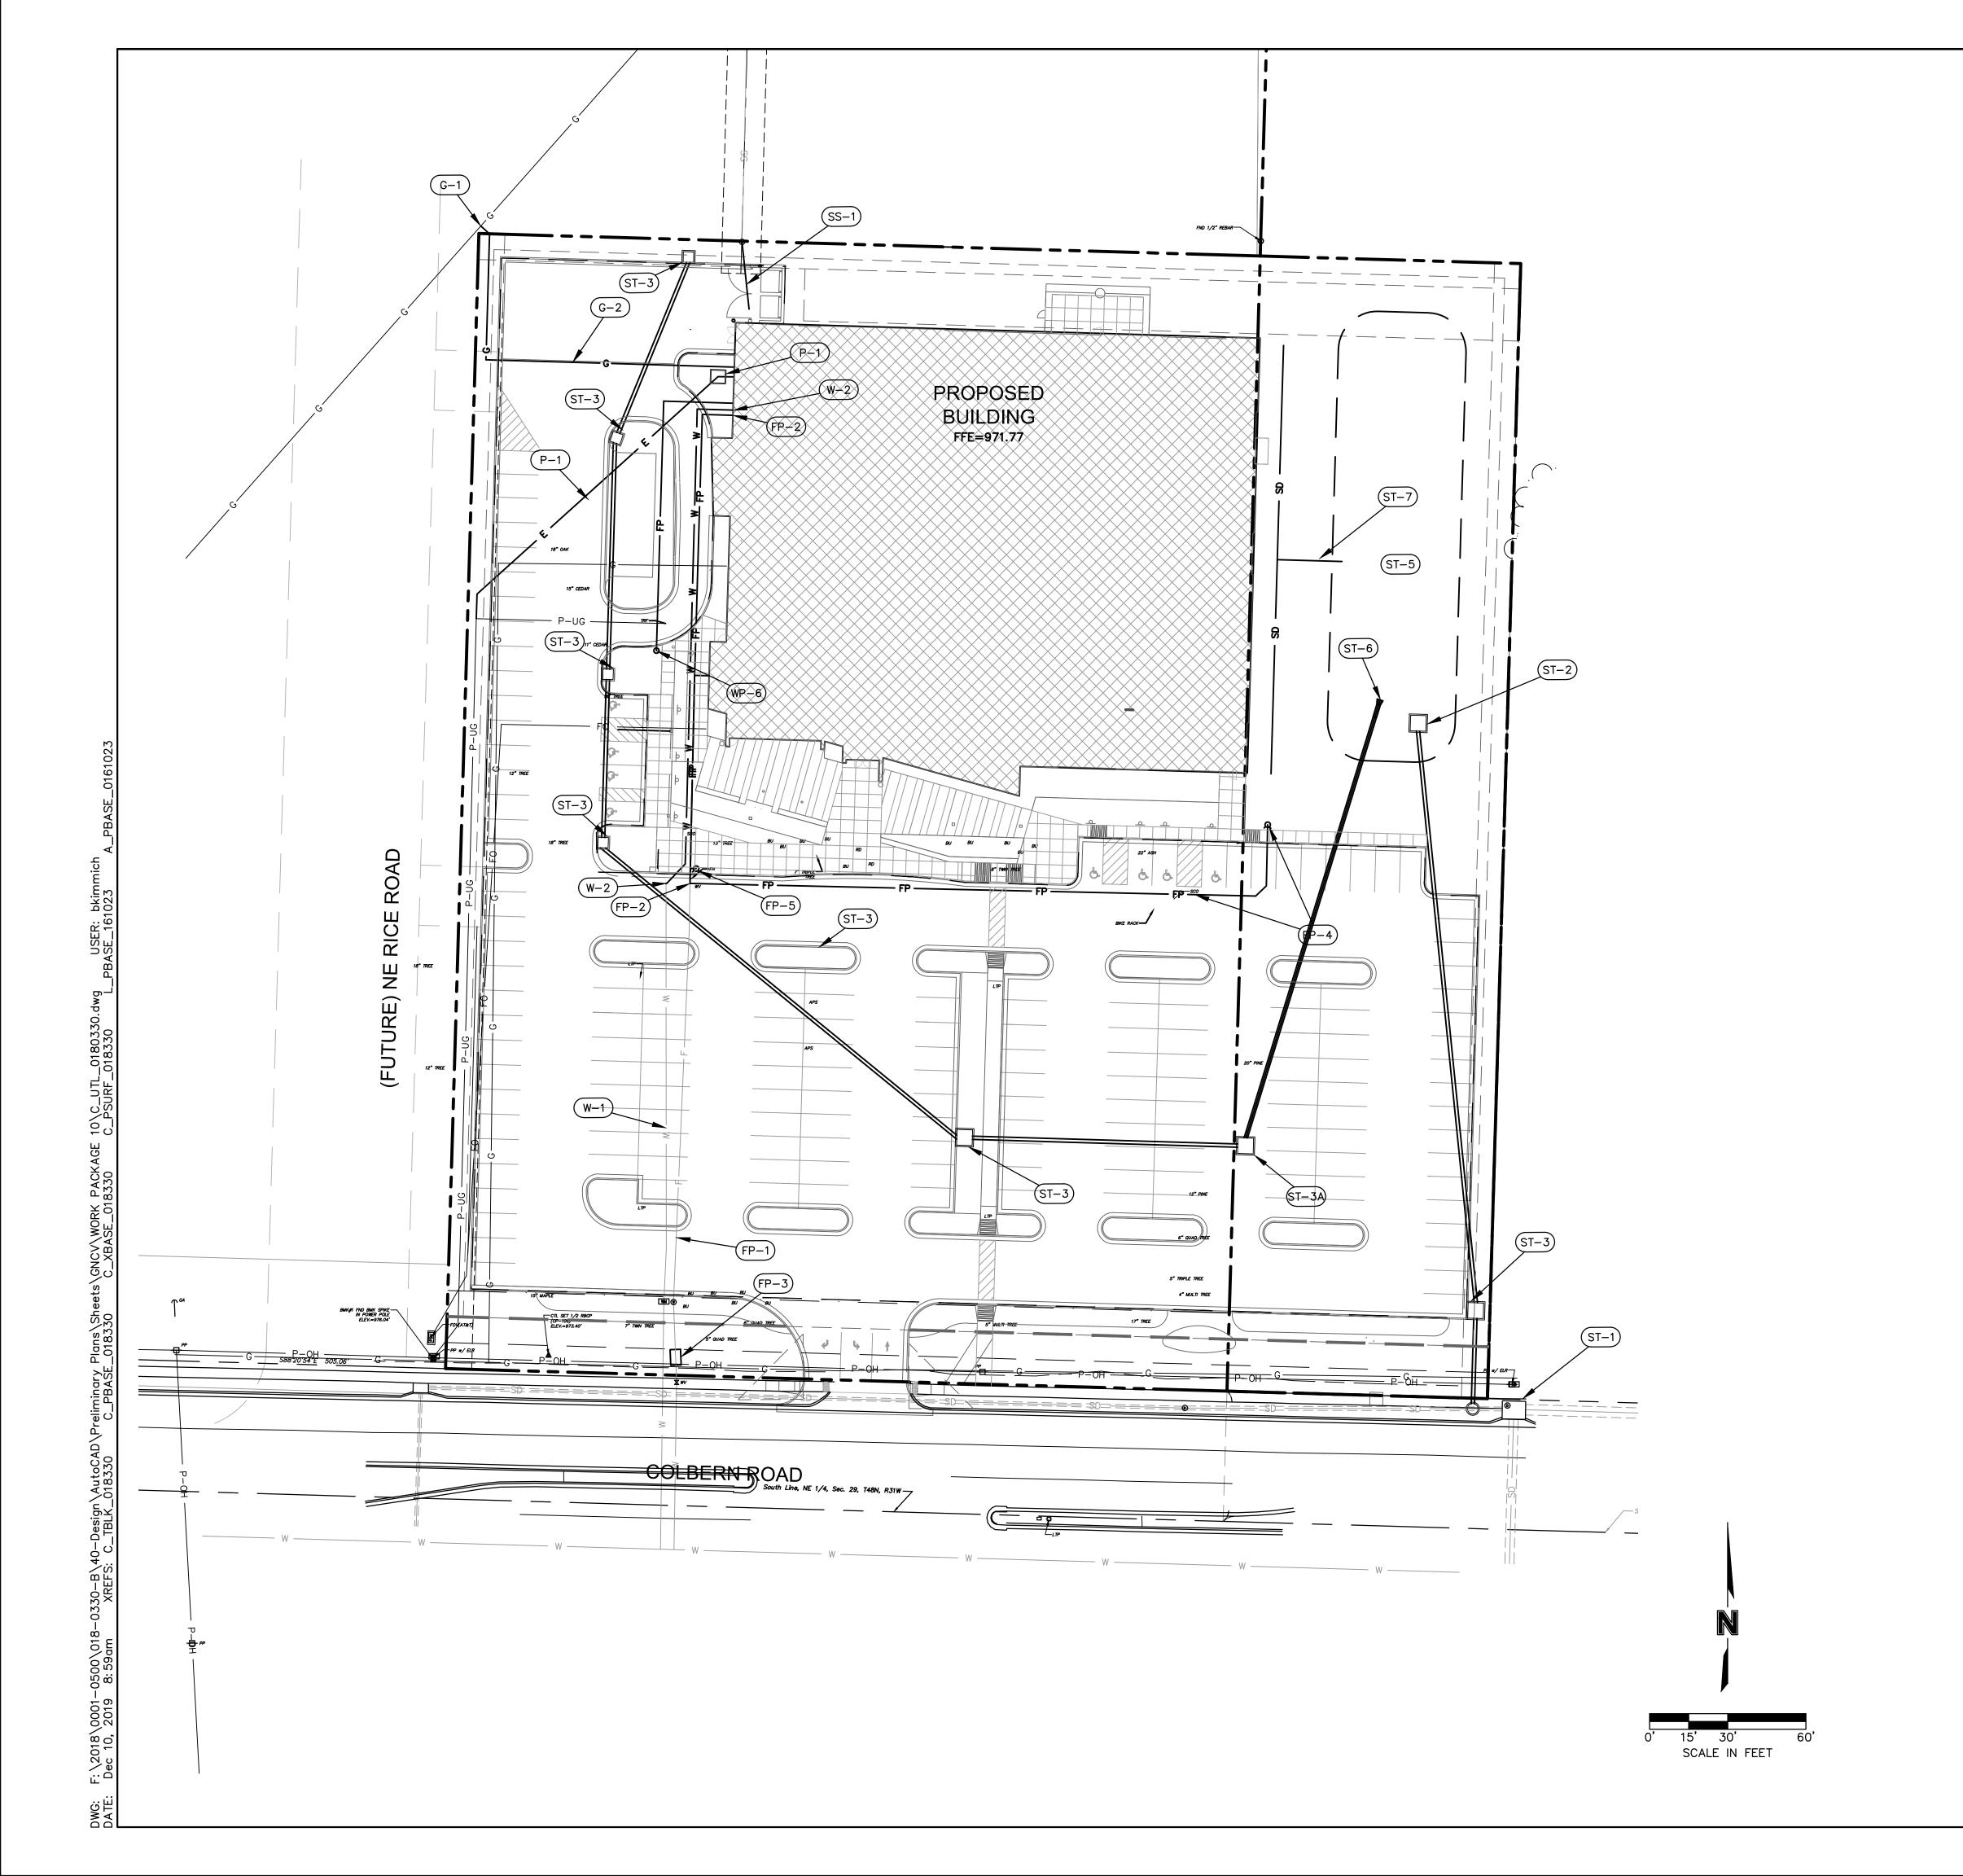

EXISTING CONDITIONS LEGEND

	Pl
	RI
	E٨
———— P-OH ————	0
P-UG	U
TEL	U
FO	U
G	G
W	W
<u> </u>	S
SS	S

PROPERTY LINES RIGHT-OF-WAY LINES EASEMENT LINES OVERHEAD ELECTRIC UNDERGROUND ELECTRIC UNDERGROUND TELEPHONE UNDERGROUND FIBER OPTIC GAS LINE WATER LINE STORM SEWER LINE SANITARY SEWER LINE

PROPOSED CONDITIONS LEGEND

——— Е ———	PROPOSED UNDERGROUND ELECTRIC
——— F0 ———	PROPOSED FIBER OPTIC
—— w ——	PROPOSED WATER LINE
FP	PROPOSED FIRE PROTECTION LINE
SD	PROPOSED STORM SEWER LINE
T	PROPOSED TURF DRAIN LINE
ss	PROPOSED SANITARY SEWER SERVICE
	CONCRETE CURB & GUTTER

PROPOSED BUILDING

UTILITY KEYNOTES:

(XX)---

<u>WATER</u>

W-1 EXISTNIG 2" SERVICE LINE TO REMAIN

W-2 EXTEND 2" EXISTING SERVICE TO PROPOSED BUILDING

FIRE PROTECTION

FP-1 EXISTING 6" FIRE SERVICE TO REMAIN

- FP-2 EXTEND 6" FIRE SERVICE LINE TO PROPOSED BUILDING
- FP-3 INSTALL BACK FLOW PREVENTOR ON EXISTING FIRE PROTECTION LINE
- FP-4 INSTALL 6" FIRE LINE W/ HYDRANT
- FP-5 RELOCATE EXISTING HYDRANT
- FP-6 FIRE DEPARTMENT CONNECTION (4" STORZ FITTING)

SANITARY SEWER

SS-1 INSTALL 4" PVC SERVICE LINE TO PROPOSED BUILDING

STORM SEWER


- ST-1 CONNECT TO EXISTING CURB INLET
- ST-2 CONSTRUCT CONTROL STRUCTURE
- ST-3 CONSTRUCT CURB INLET
- ST-3A CONSTRUCT GRATE INLET
- ST-4 CONSTRUCT STD 4' DIAM MANHOLE
- ST-5 EXTENDED DRY DETENTION BASIN
- ST-6 INSTALL STD 24" FLARED END SECTION
- ST-7 ROOF DRAINS TO DETENTION BASIN

<u>POWER</u>

- P-1 PRIMARY SERVICE -COORDINATE WITH EVERGY.
- P-2 PROPOSED TRANFORMER LOCATION COORDINATE WITH EVERGY AND MEP.

<u>GAS</u>

- G-1 CONNECTION TO EXISTING GAS LINE. COORDINATE WITH ASPIRE.
- G-2 INSTALL 1 1/2" GAS SERVICE TO PROPOSED BUILDING

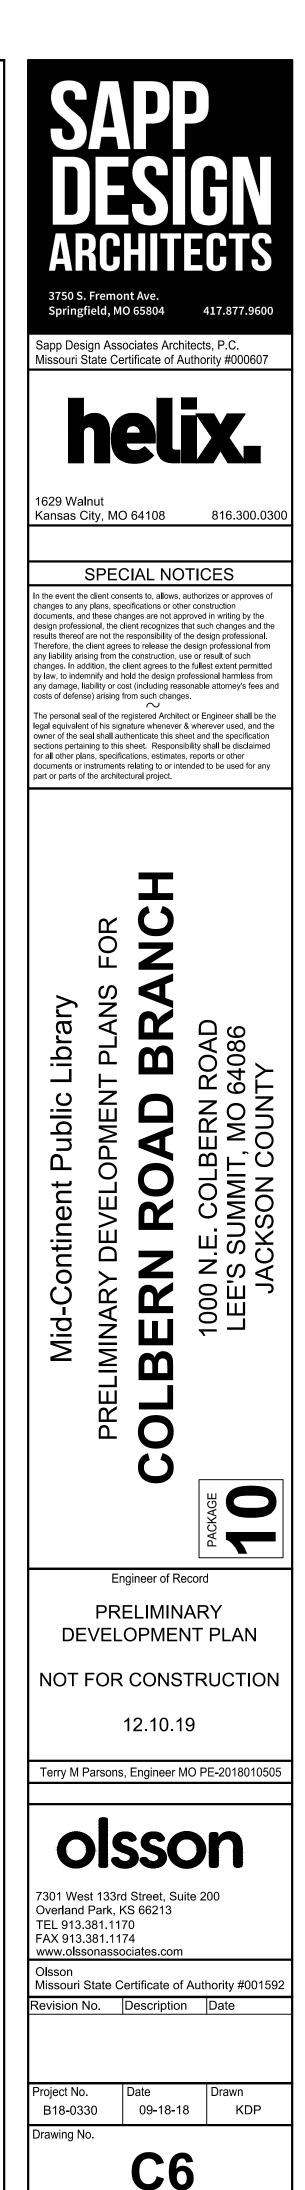

UTILITY PLAN

opyright 2018 - Sapp Design Associates, Architects, P.C.

