

### Local Benchmarks: \_\_\_\_\_BM-#

BM-1: (Chiseled box on the southeast corner of a 6'X4' curb inlet. First inlet south of intersection of SE Oldham Parkway and SE Century Drive. On the east side of SE Century Drive.) Elevation: 1011.71'

N: 995663.268

E: 2828905.632

BM-2: (Chiseled box in the center line on the east side of a 7'X5' curb inlet north side of the furthest east island in the Home Depot parking

Elevation: 1025.66'

N: 995397.712

E: 2828534.125



#### <u>Symbols</u>

sanitary manhole

service cleanout

force main release valve

rectangular structure

circular structure

fire hydrant

water meter

backflow preventer

natural gas meter

service transformer (pad mount)

primary switch gear

light pole

cable/phone/data junction box

pedestrian street light

end section

### <u>Property Legend</u>

---- easements

### <u>Grading Legend</u>

existing minor contour existing major contour proposed minor contour proposed major contour

### <u>Utility Legend</u>

existing proposed <u>Linetypes</u> storm sewer (solid wall, proposed) storm sewer (perforated, proposed)

water service (domestic) water service (irrigation)

underground cable/phone/data underground cable/phone/data service

natural gas service schematic underground primary electric underground secondary electric



Silt fence

concrete washout area



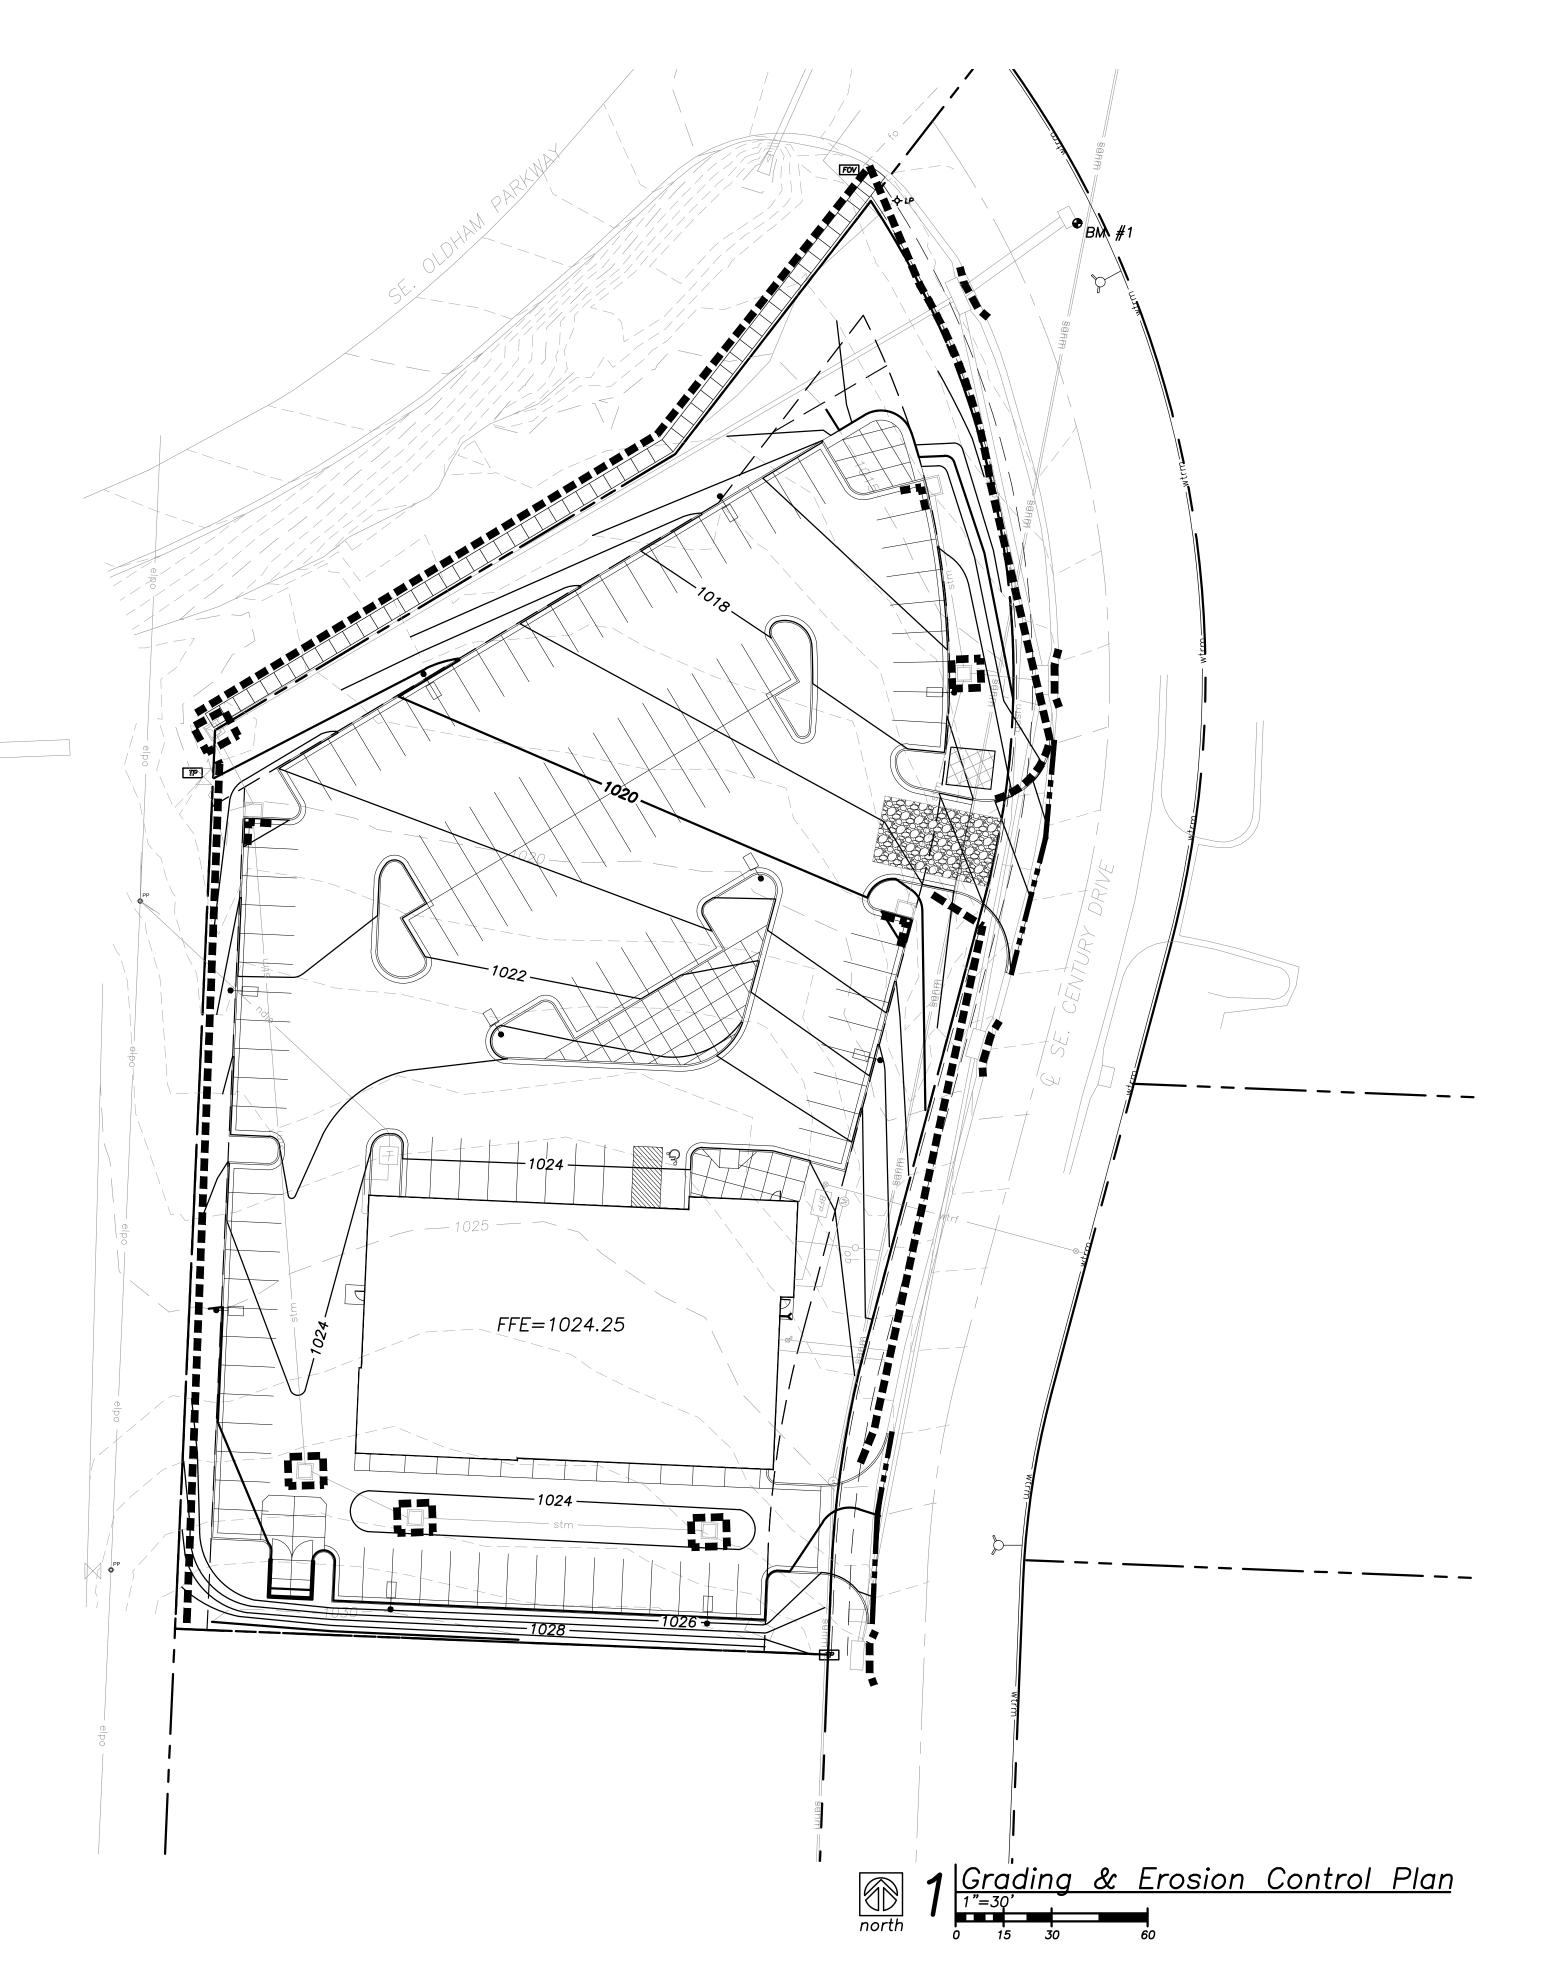
Inlet protection construction entrance

waddle






**⊕** BM #2



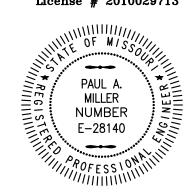4301 Indian Creek Parkway Overland Park, KS 66207 phone: 913.451.9390 fax: 913.451.9391 www.davidsonae.com

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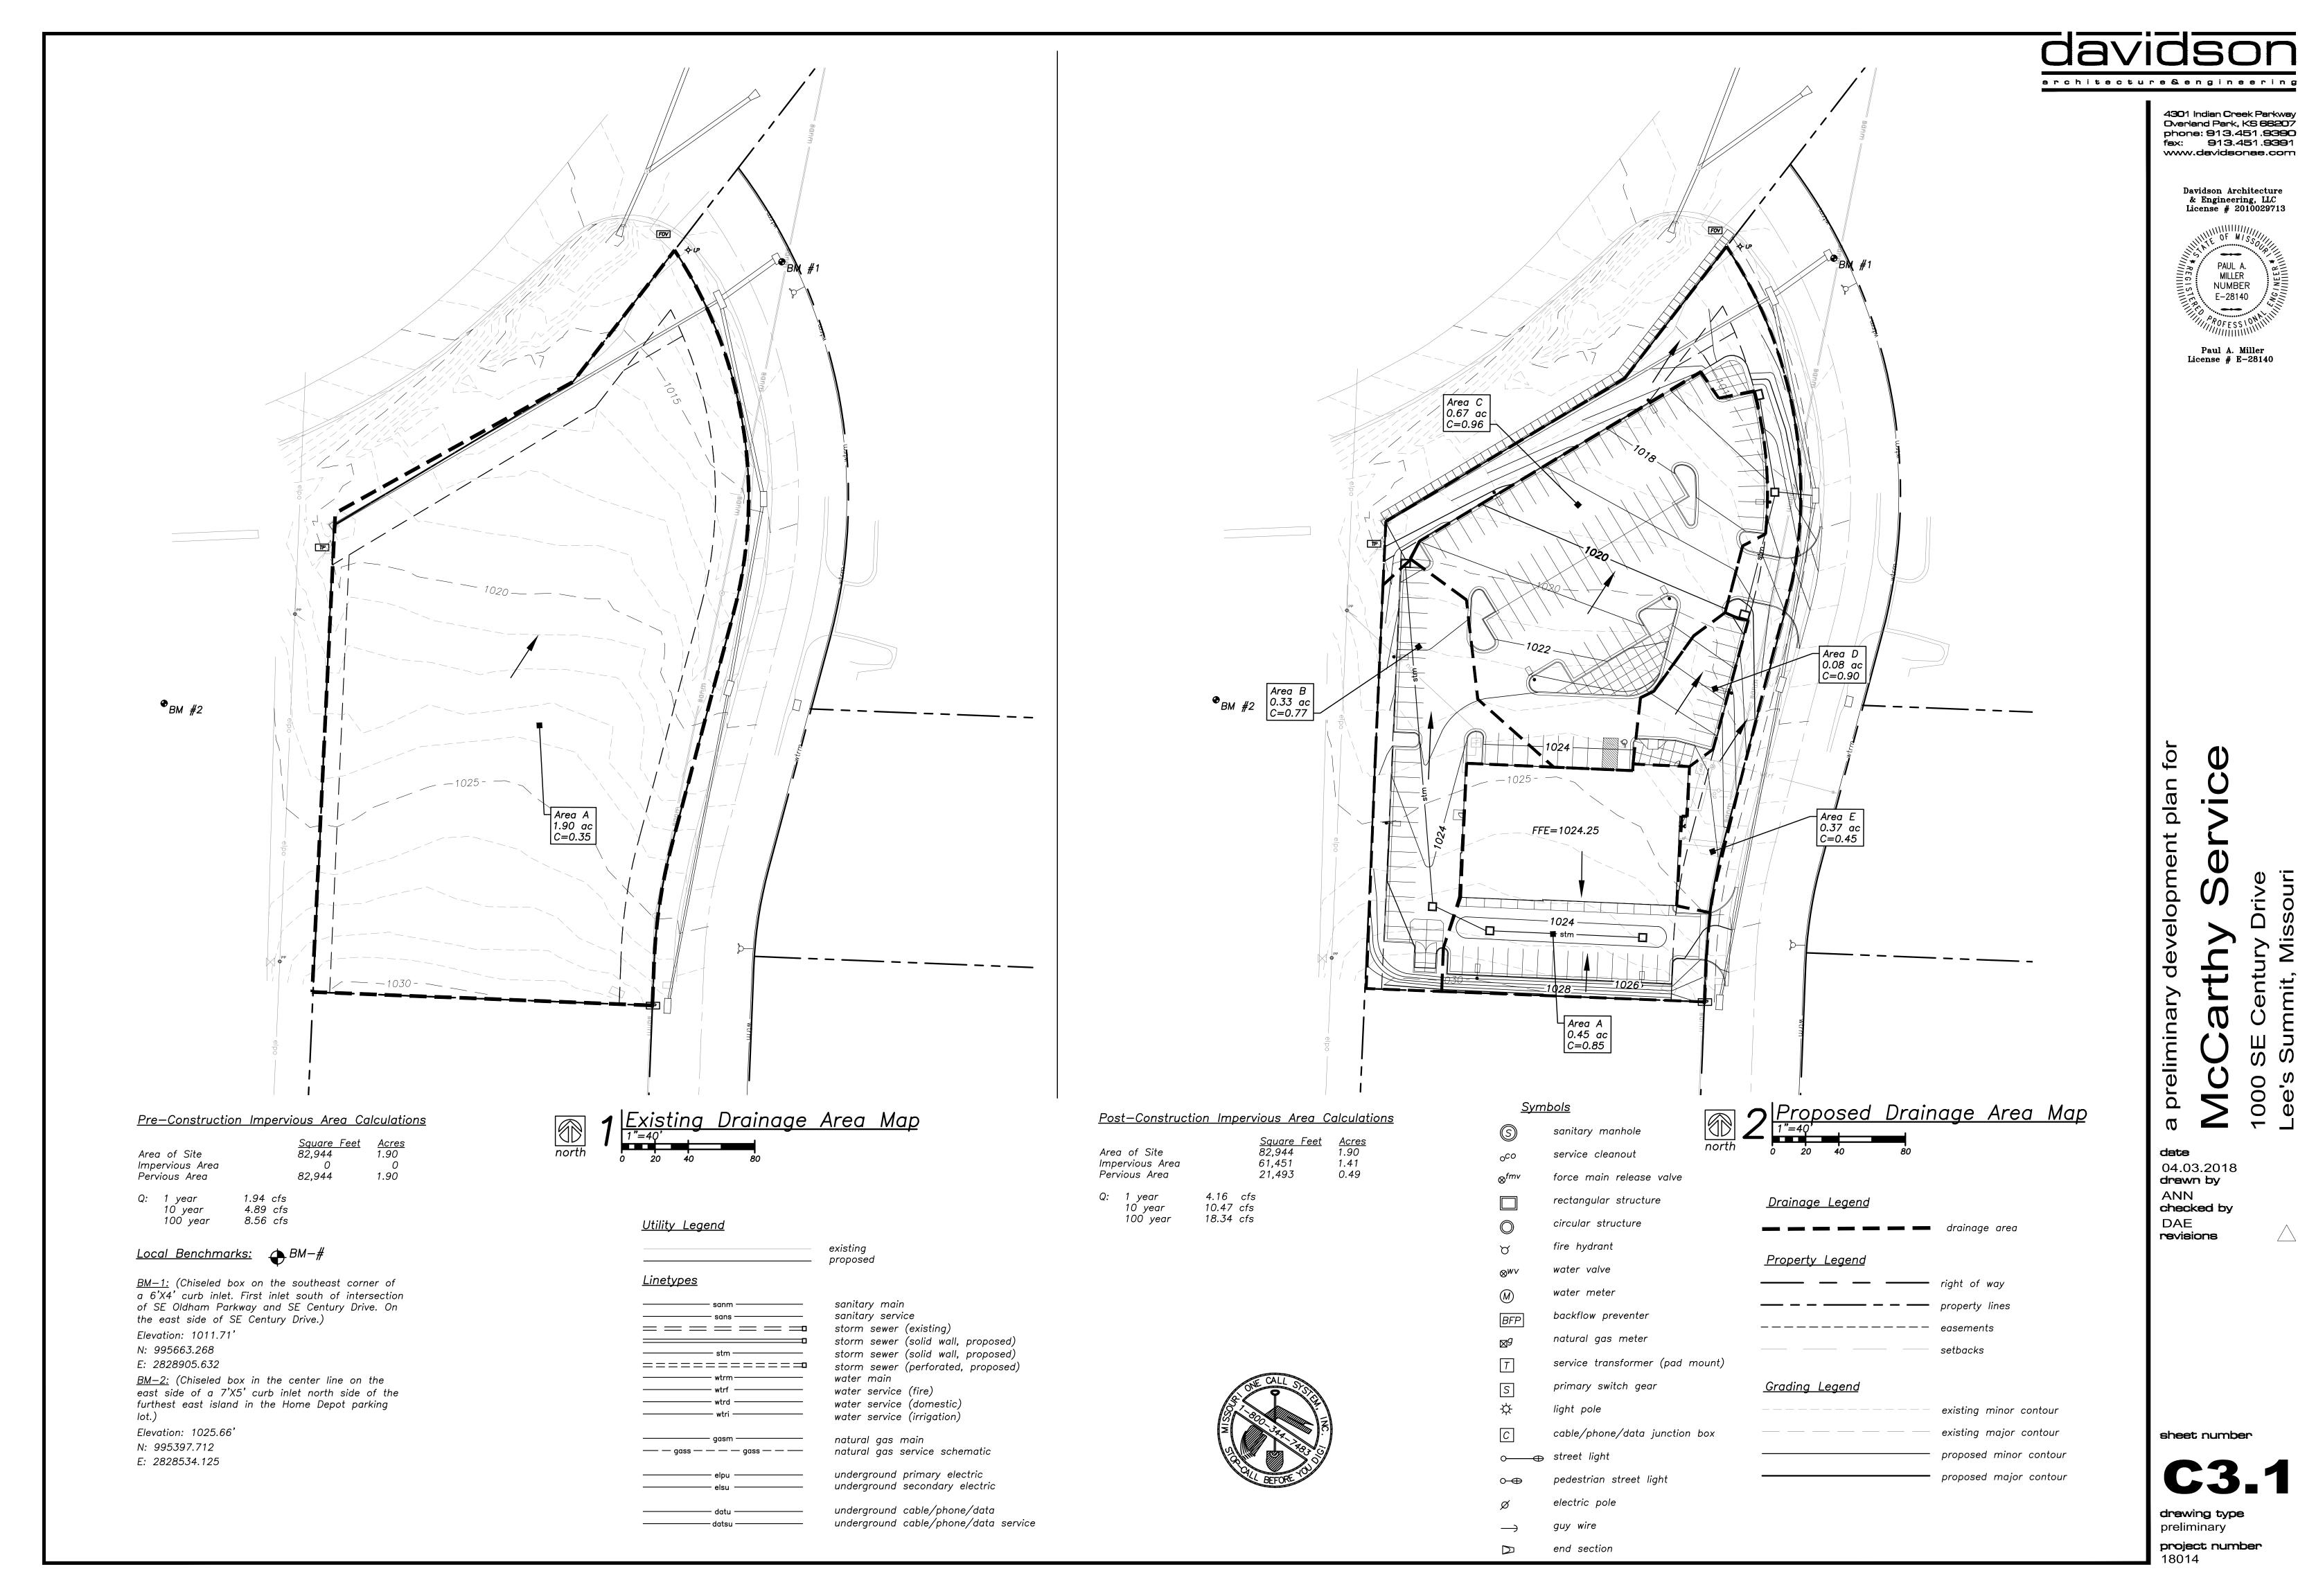


Paul A. Miller License # E-28140

plan for development

date 04.03.2018 drawn by ANN checked by DAE revisions

sheet number



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#### Landscape Requirements

82,944 sq. ft., 1.9 acres Site Area: Impervious Area: 61,451 sq. ft. Coverage Ratio: 74.1% Green Space: 21,493 sq. ft. Coverage Ratio: 25.9%

Open Area Shrubs:

2 per total lot area/ 5,000 sq.ft

82,944 sq. ft. / 5,000 x 2 = 33.2 required, 33 shrubs providedOne per total lot area not covered by building/ 5,000 sq.ft

72254 sq.ft. / 5,000= 14.5 required, 15 trees provided

20' landscape strip provided 408 l.f. / 30' = 13.6 required trees and 14 trees provided

Street Frontage @ East

408 l.f. / 20' = 20.4 required shrubs and 21 shrubs provided

Street Frontage @ Northwest 20' landscape strip provided 267.6 l.f. / 30' = 8.9 required trees and 9 trees provided 267.6 l.f. / 20' = 13.4 required shrubs and 14 shrubs provided

Buffer @ South

CP-2 bordering PI (Planned Industrial) Medium Impact Screening required along 204 I.f. x 20' depth = 4080 s.f. Shade Tree: 1/1000 s.f. = 4 required and 4 provided Ornamental Tree: 1/500 s.f. = 8 required and 8 provided Evergreen Tree: 1/300 s.f. = 13.6 required and 14 provided. Shrubs: 1/200 s.f. = 20.4 required and 21 provided.

Parking and Loading Area Landscaping Parking area: 49,020.4 5% of parking area required = 2,451 sq. ft. landscaping required 5.8% of parking area provided = 2859.7 sq. ft. landscaping provided

64 total trees required, 20 shade trees 14 evergreen, 30 ornamental provided = 64 provided. 56 total shrubs required, 166 provided (additional shrubs per 100% parking screening)

				plant so	chedule	
		item	qty.	common name	botanical name	size & condition
shade trees		og	8	october glory maple	acer rubrum 'october glory'	3" cal.
deciduous shade trees	°	SI	12	skyline locust	gleditsia tricanthos inermis 'skycole'	3" cal.
evergreen		wp	14	white pine	pinus strobus	8' tall
ornmntl.		rb	18	redbud	cercis canadensis	3" cal.
ornr	0	cd	12	spring snow crabapple	malus 'spring snow'	3" cal.
evgn. shrub	٥	wb	37	wintergreen boxwood	buxus microphylla	24-30 " b & b or 5 gal. / cont.
dec. shrub	$\odot$	lps	75	'little princess' spirea	spirea japonica 'little princess'	24-30 " b & b or 5 gal. / cont.
dec.	$\odot$	cwe	54	'goldenflame' spirea	spirea x bumalda	24-30 " b & b or 5 gal. / cont.

Landscaping shall be coordinated with the location of utilities, driveways and traffic clearance zones.

The contractor doing excavation on public right-of-way shall give 48 hours advance notice to and obtain information from utility companies. Prior to commencement of work, the contractor shall notify all those companies which have facilities in the near vicinity of the construction to be

Existing underground, overhead, utilities and drainage structures have been plotted from available information and therefore, their locations must be considered approximate only. It is the responsibility of the individual contractors to notify the utility companies to locate their utilities before actual

Contractor shall verify location of and protect all utilities and structures. Damage to utilities and structures shall be repaired by the contractor to the satisfaction of the owner at no additional expense.

Entire site to be irrigated by underground system, including right of way as req'd. (limits of sod including all other disturbed area's and all planting

Irrigation system shall include an automatic rain sensor. All landscape materials shall be installed in accordance with the current planting procedures established by the most recent addition of the American

Standard for Nursery Stock. Trees planted per this plan shall be installed during the spring (march 15 through june 15) or fall (september 15 through december 1). Written city approval will be required for planting during other times of the year.

0. Stake and guy all trees per planting details. 11. Install all shrubs and groundcover per planting details.

landscape notes:

12. Elevation of top of mulch shall be 1/2" below any adjacent pavement/turf areas.

13. Root stimulator shall be applied to the soil backfill of each plant during installation.

14. Contractor shall verify all landscape material quantities and shall report any discrepancies immediately to the Landscape Architect. 15. Contractor shall stake plant locations in the field and have approval by the Landscape Architect before proceeding with installation.

16. Contractor shall guarantee all plant material for a period of one (1) year from date of initial acceptance. Contractor is responsible for maintaining plant material until acceptance is received. Maintenance shall include watering, maintaining plants in vertical position and shrub bed weed control.

17. All plant material shall meet or exceed minimum requirements defined by the "American Standard for Nursery Stock" ANSI Z60.1. 18. No plant material shall be substituted without written approval of the Landscape Architect per specifications. 19. Trees and seasonal color areas shall be mulched with three (3) inches minimum shredded hardwood mulch. Planting beds as delineated shall be

separated from pavement/turf areas with metal edging and mulched with three (3) inches minimum shredded hardwood mulch over weed barrier

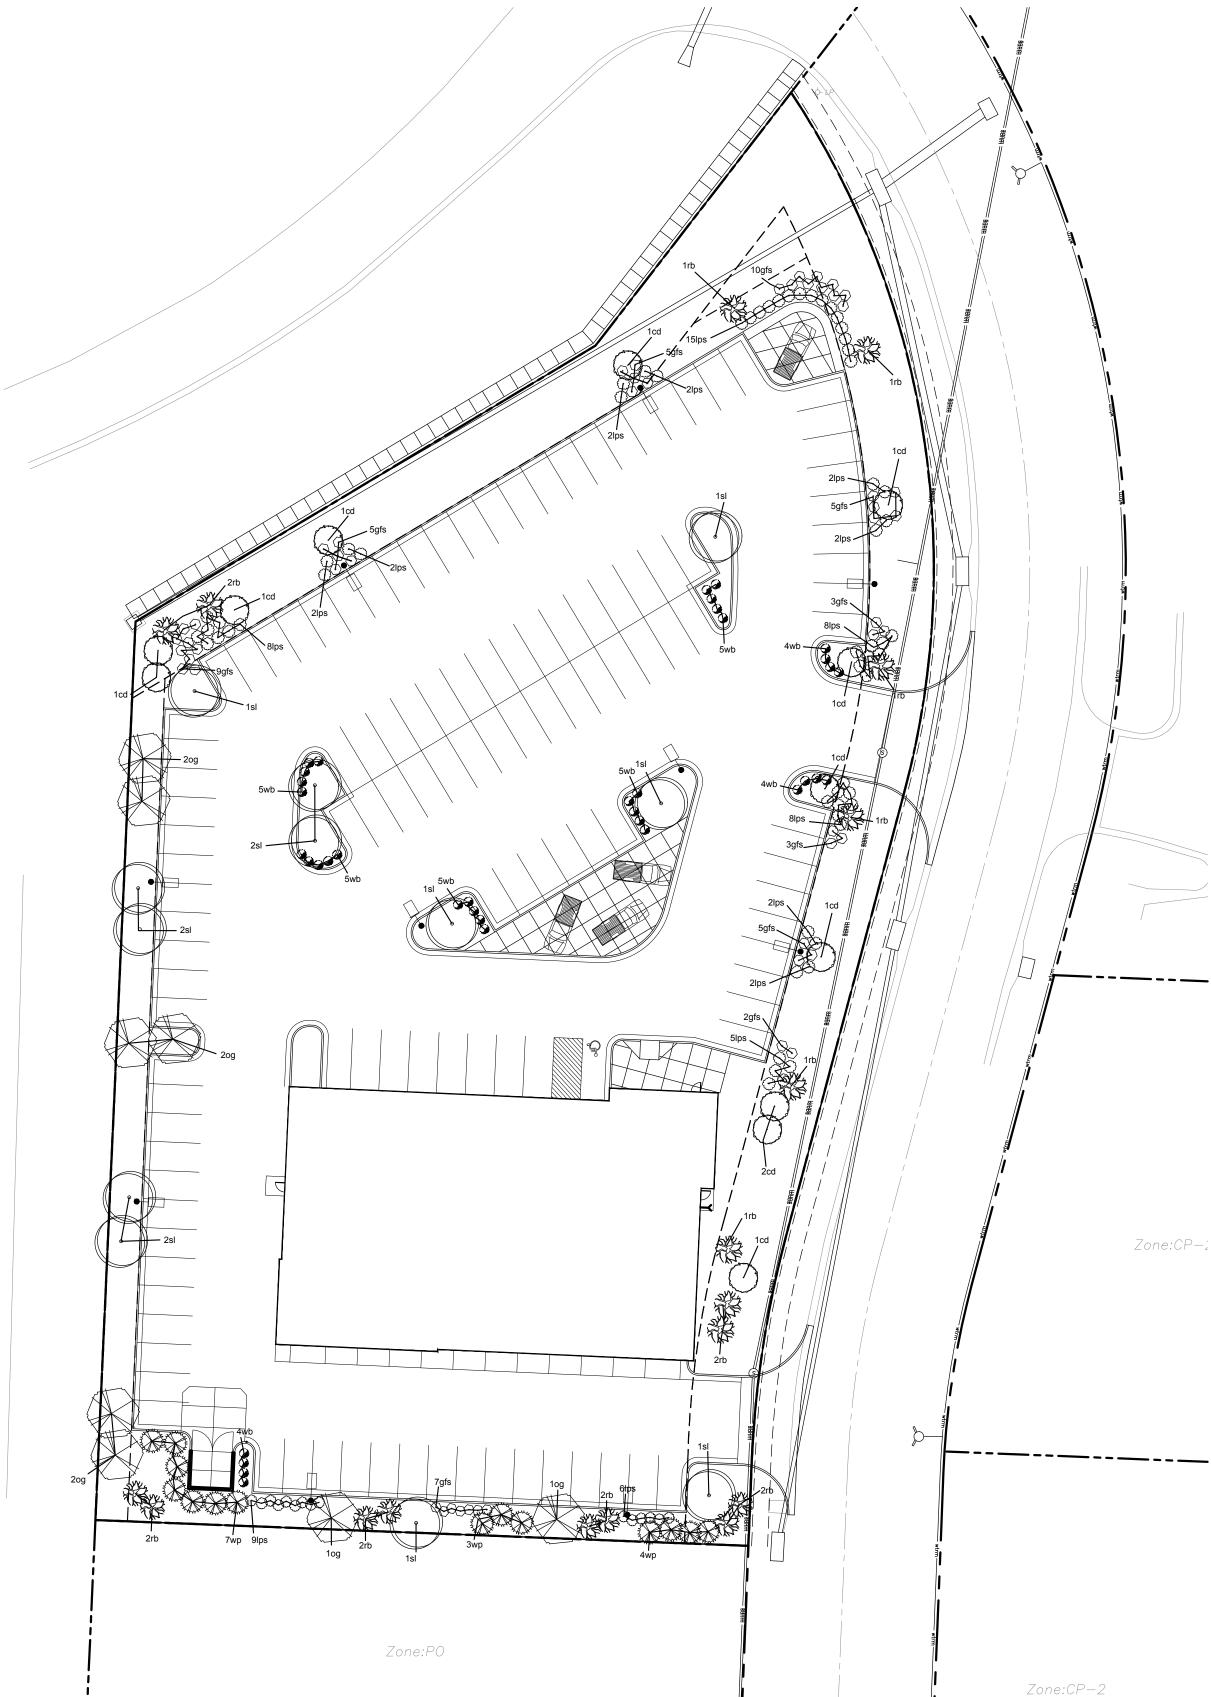
20. All existing plant material to be retained shall be wrapped with orange, or bright, colored plastic snow fence around base of trees and around all

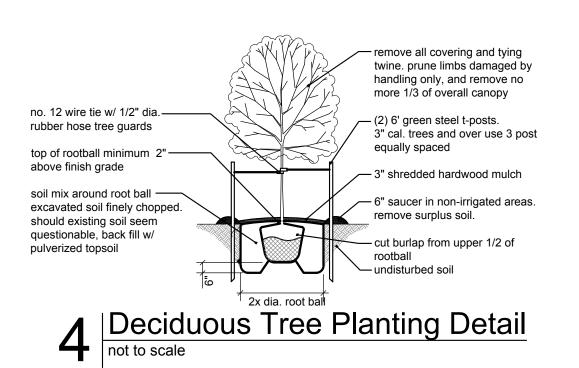
shrubs. Stake to hold in place during construction. 1. All shrubs used as parking buffer to be min. 18" tall at planting and maintained 3'-0" max. height. Install plants not to encroach upon cars parked,

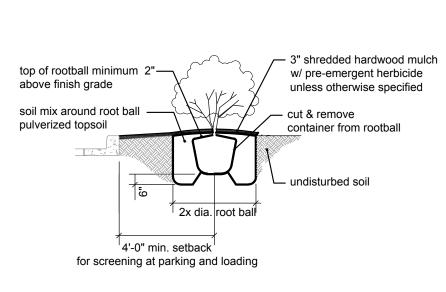
when at full growth. 22. All trees with above a 2" caliper shall be double staked, while smaller trees shall be single staked.

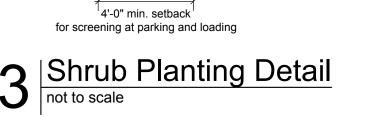
23. Ground mechanical and electrical equipment shall be wholly screened from street right-of-way and residential developments.

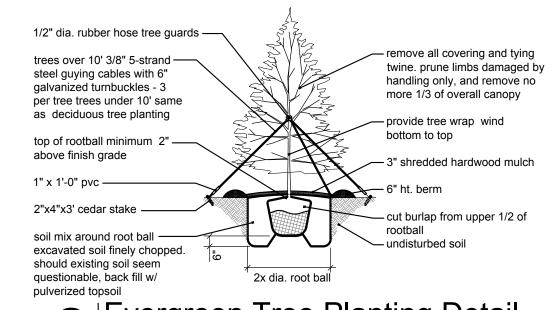
24. Maximum slope shall be not greater than 3 : 1. 25. All portions of site not covered by paving, mulch, plantings, etc. are to be sodded. Sod shall extend to all disturbed areas and shall include portions of right of way if necessary.











2 Evergreen Tree Planting Detail not to scale



drawing type preliminary

project number

plan

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eliminary

04.03.2018 drawn by WJD

checked by

DAE revisions

Zone:CP-2

Luminaire Sch	hedule					
Symbol	Qty	Label	Arrangement	Total Lamp Lumens	LLF	Description
	6	A-2	TWIN	N.A.	0.900	VISIONAIRE VLX-1-T5W-128LC-7-4K-UNV_CLS-GG
<b>→</b>	2	A-1	SINGLE	N.A.	0.900	VISIONAIRE VLX-1-T5W-128LC-7-4K-UNV_CLS-GG
	5	WALL	SINGLE	N.A.	0.900	VISIONAIRE VSC-1-T4-48LC-3-3K-UNV GG
9	4	B-4	4 @ 90 DEGREES	N.A.	0.900	VISIONAIRE VLX-1-T4A-192LC-7-4K-UNV_CLS-GG

Numeric Summary							
Label	CalcType	Units	Avg	Max	Min	Avg/Min	Max/Min
CENTER ISLAND FOR SH	OM/uminance	Fc	18.33	34.9	3.9	4.70	8.95
PARKING LOT	Illuminance	Fc	12.64	43.8	1.0	12.64	43.80

Helio Will
I am working on this, but I have questions on this.

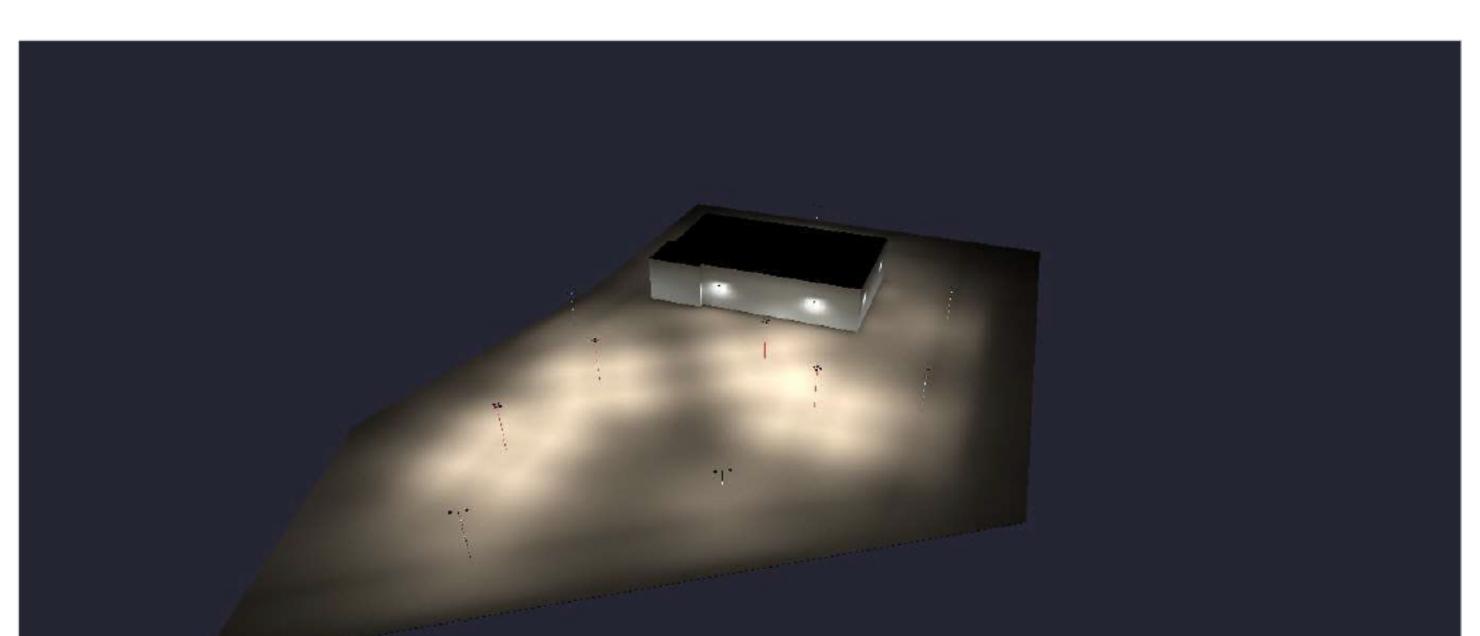
1.Bidg height-need for reflectances and get an accurate calculation. Please see attached CAD elevations (126'-10' max)

2.Bidg. mounted lighting ok to use? Yes. Elevations are included to help with placements.

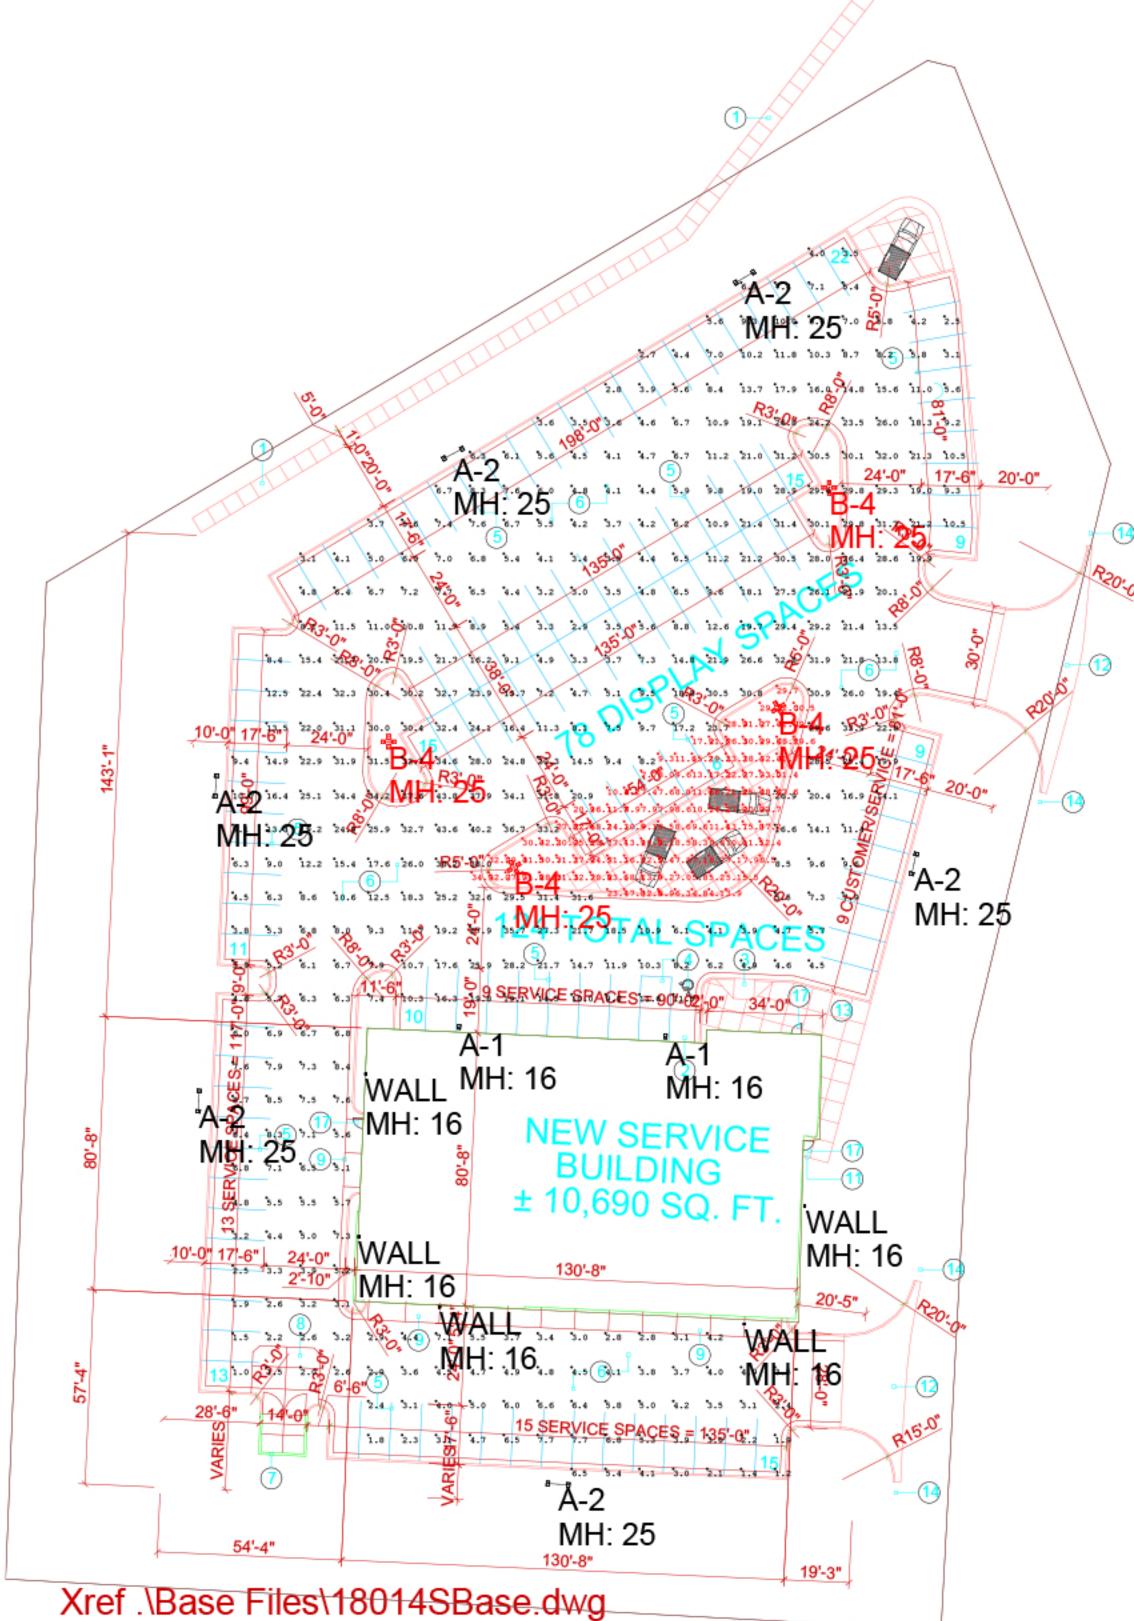
3.Footcandles required for dealership- from visicenter of lot. Befer to Lee's Summit UDO (link below, see section Light Standards)

3.Footcandles required for dealership- front row vs center of lot. Refer to Lee's Summit UDO (link below, see section Light Standards)
4.Is this an addition to dealership or entire new site- I ask because is this a match existing lighting. This is a new site. It is for a dealer across the street at 945 SE Clidham Plwy, Lee's Summit, MO 64081... I would try to match them roughly with the ones across the street. But it doesn't need to be exact.

5.Property line- do we need to show in calc- show 0 footcandles beyond property line Refer to Lee's Summit UDO (link below, see section Light Standards)
6.No Lighting placement was given, so can we put in Islands and in grass around property perimeter. Please see updated site plan with some lights around the perimeter. We added these to be representational for our submission, if they need to shift that is ok.









		:				
	Drawn By: GREGG GARNER	#	Date	Comments		
McCarthy Lee Summit	Checked By:	Re				Lightir
laire Calc-	Date:3/6/2018	evis			w.agi3	Since 1
PREMIER LIGHTING		ion			haver	
		ıs				
	Scale:					

Page M of 1

### 3 trash enclosure plan scale: 1/4" = 1'-0"

\*note: all steel to be epoxy

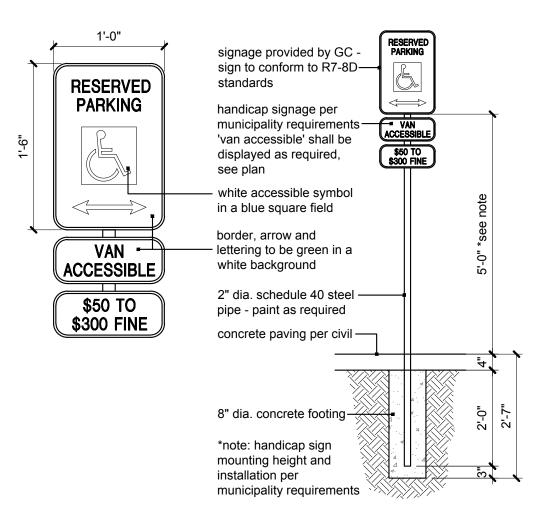
\*note: all steel to be epoxy

painted to match primary building color pre-finished flush metal panel with perimeter "J" trim with weep at bottom collar hinges top and bottomwith grease zert, epoxy paint 2" galvanized tube steel frame epoxy paint 6" dia. galv. steel post set into footing per structural - fill with concrete and dome top - epoxy hinge stop welded in place, epoxy paint heavy duty galvanized flush bolts —+ with holes drilled in concrete at fully open and fully closed positions

## trash enclosure front elevation scale: 1/4" = 1'-0"

painted to match primary building color collar hinges top and bottomwith grease zert, epoxy paint pre-finished metal cap flashing with continuous wind cleat over 2x pressure treated wood nailer cap 6" dia. galv. steel post set into footing per structural - fill with concrete and dome top - epoxy hinge stop welded in place, epoxy paint concrete foundation per structural

# 5 trash enclosure side elevation scale: 1/4" = 1'-0"



6 ADA sign detail scale: 1/2" = 1'-0"

### project synopsis:

Governing Municipality: Lee's Summit, Missouri

2012 IBC, 2012 IMC, 2012 IPC, 2012 IFGC, Governing Code: 2012 IFC, 2011 NEC, 2010 ADA/ANSI 117.1

Responsible Party: Justin Bridges, AIA

4301 Indian Creek Parkway Overland Park, Kansas 66207 p: 913.451.9390

Lot 12, Eastside Business Park, a subdivision in Lee's Summit, Jackson Legal Description: County, Missouri, according to the recorded plat thereof.

Site Area: 82,944 sq. ft. (+/- 1.90 acres) 61,609 sq. ft. (74.3% Impervious Area: Green Space: 21,335 sq. ft. (25.7%)

Building Area: 10,690 sq. ft.

Floor Area Ratio: 10,690 / 82,944 = 12.9 %

CP-2 Zoning:

Parking Required:

2/1,000 sq. ft. indoor sales = 0

total = 48 spaces

1 / 2,500 sq. ft. outdoor sales @ 14,601 sq. ft. = 6 spaces 3 / service bay @ 14 = 42 spaces

14 employees & 6 customer spaces; 20 spaces = 1 ADA spot req.

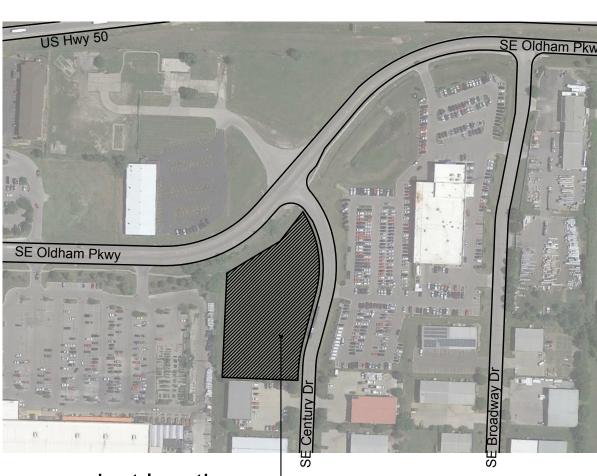
#### Parking Provided: 124 spaces

### general notes:

- All construction shall conform to the standards and specifications of the city of Lee's Summit,
- The general contractor shall contact all utility companies prior to the start of construction and verify the location and depth of any utilities that may be encountered during construction.
- The contractor shall field verify existing surface & subsurface ground conditions prior to start of
- Slopes shall maintain a maximum 3:1 slope. Refer to Civil Engineering drawings for grading
- The contractor shall be responsible for obtaining all required permits, paying all fees, and
- otherwise complying with all applicable regulations governing the project. • Place silt fence for erosion control per Civil Engineering drawings and as required.
- Provide a temporary gravel access drive to prevent mud from being deposited onto the
- Prior to installing any structure on a public storm sewer, the contractor shall submit shop drawings for the structure(s). Installation shall not occur until drawings have been approved by
- Prior to installing, constructing, or performing any work on the public storm sewer line (including connecting private drainage to the storm system) contact the city for inspection of the work. contact must be made at least 48 hours prior to the start of work.
- Connections to the public storm sewer between structures will not be permitted.
- All above ground utility termination points shall be screened from view with appropriate landscaping and shall be painted to match the primary adjacent wall color.
- Prior to final inspection, the general contractor shall meet with the Lee's Summit Fire Department to designate fire lane and fire lane sign locations to be installed per Fire Department direction and requirements.

### construction notes: #

- 1. . 4" thick with 6x6 10/10 wwf steel mesh. Control joints at 5'-0" o.c. Broom finish for non-slip
- 2. Handicap parking signage. Mount sign at not more than 60" a.f.g. to bottom. Sign to contain the universal handicap symbol and "van accessible" as required per ADA.
- Furnish and install ADA accessible ramp and sidewalk per civil.
- Handicap striping and universal symbol painted white with 4" stroke.
- Parking lot striping to be painted white with 4" stroke.
- Asphalt and concrete parking lot paving shall meet city of Lee's Summit, Missouri construction
- Furnish & install trash enclosure per detail.
- Furnish & install concrete pad at trash enclosure per civil. 9. Furnish and install concrete apron per civil.
- 10. Location of FDC. Verify final placement with Lee's Summit Fire Department prior to installing. 11. Furnish and install a Knox Box at 6'-0" a.f.g over the FDC for fire department access. Verify
- final placement with Lee's Summit Fire Department prior to installing. 12. Furnish & install new concrete drive approach, sawcut existing curb & gutter as required to
- install drive approach. Match new approach elevation with existing surface. 13. Concrete sidewalk. 4" thick with 6x6 10/10 wwf steel mesh. Control joints at 6'-0" o.c. Broom
- finish for non-slip surface. 14. Existing curb to remain.
- 15. Parking lot lighting, LED light on 28' high pole with 36" high, 24" dia. concrete base. Locate per electrical drawings.
- 16. Furnish and install frost depth concrete stoop at all exterior doors per structural, typ.
- 17. Concrete sidewalk at display area. 6" thick with 6x6 10/10 wwf steel mesh. Control joints at
- 5'-0" o.c. Broom finish for non-slip surface. 18. Furnish and install limestone boulder retaining wall to form front edge of display pad.
- 19. Future 5'-0" wide concrete sidewalk




project location -







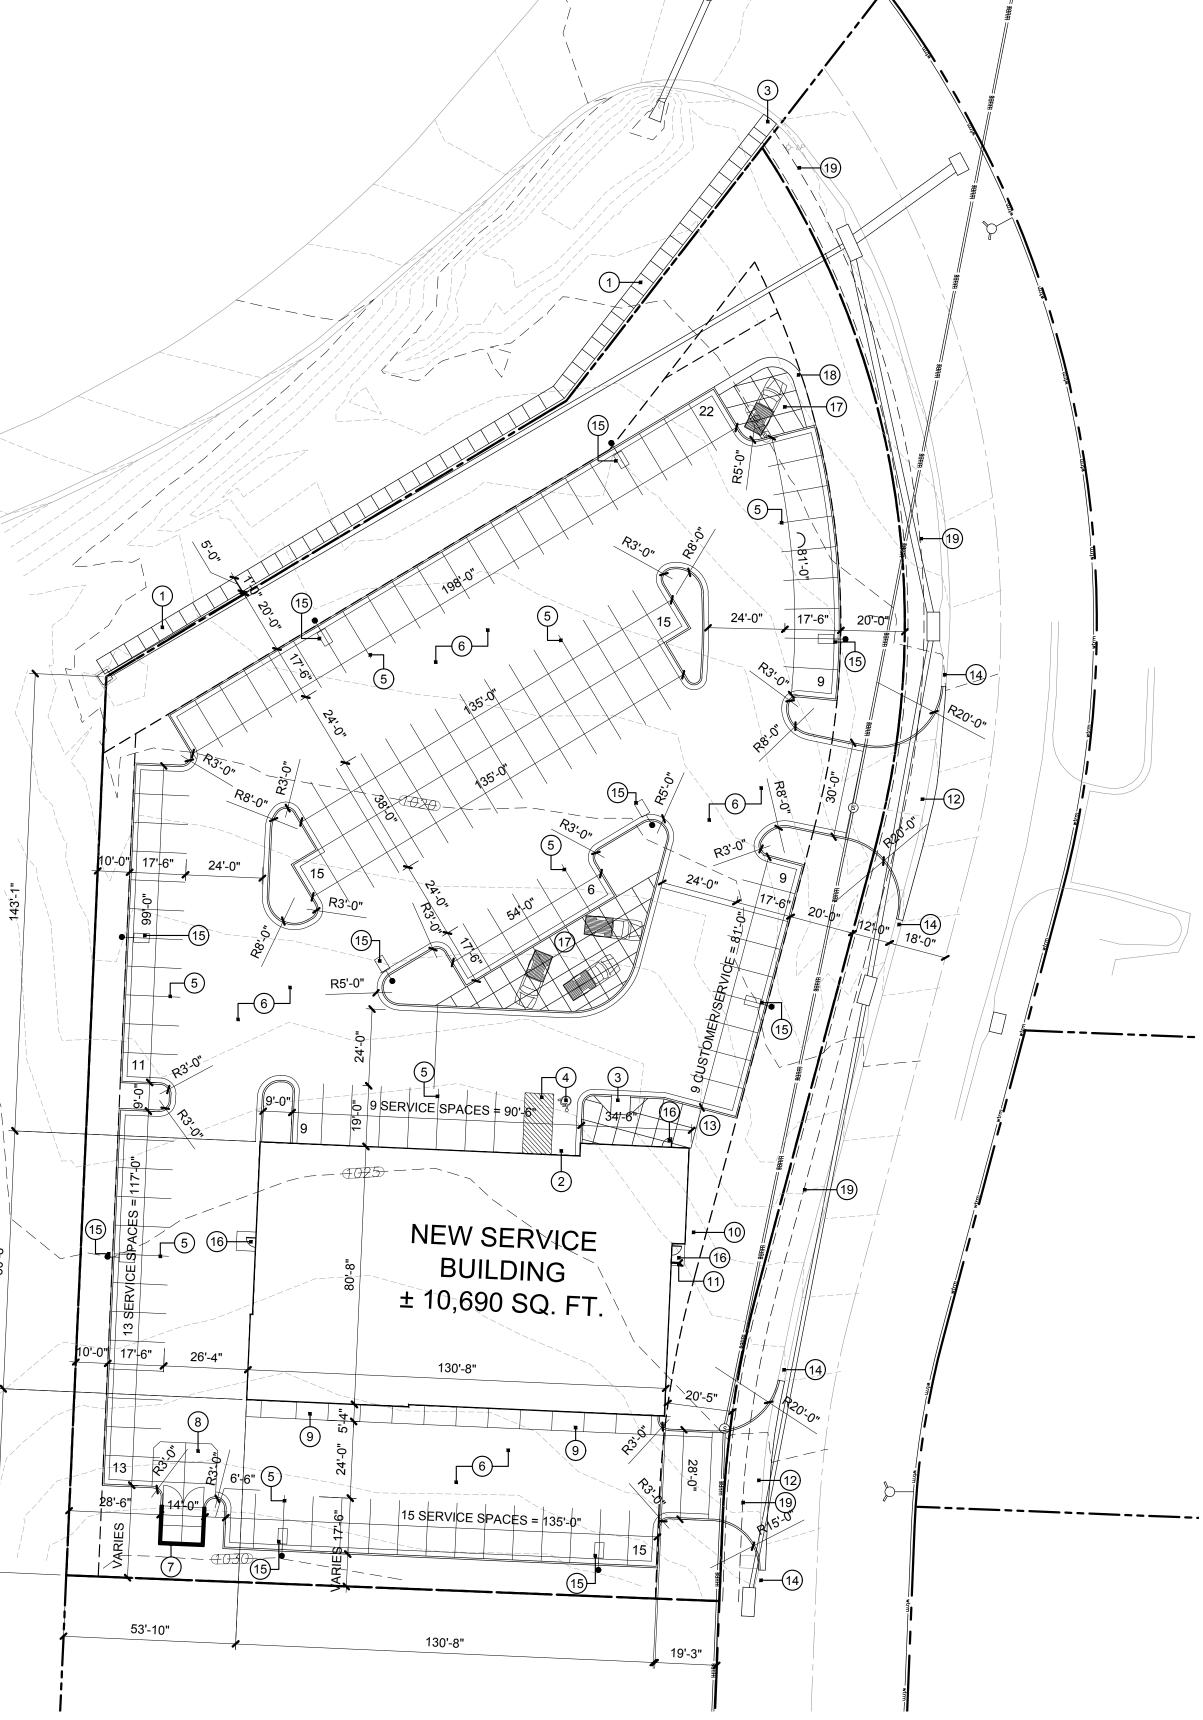4301 Indian Creek Parkway Overland Park, KS 66207 phone: 913.451.9390 fex: 913.451.9391 www.devidsonee.com



date 04.03.2018 drawn by WJD checked by DAE revisions

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sheet number



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south elevation



2 | west elevatio



3 east elevation scale: 1/8" = 1'-0"



4 | north elevation | scale: 1/8" = 1'-0"

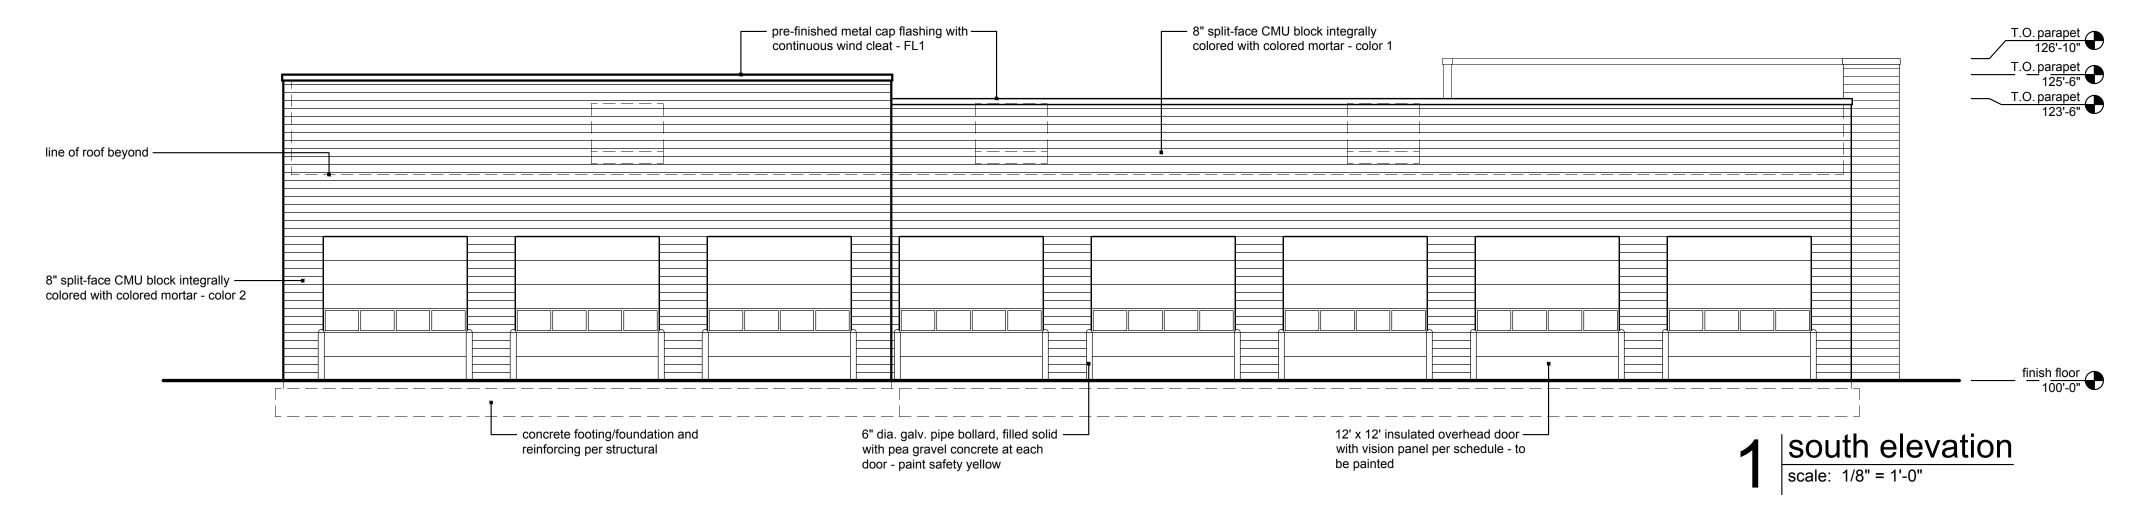
a preliminary development plan for

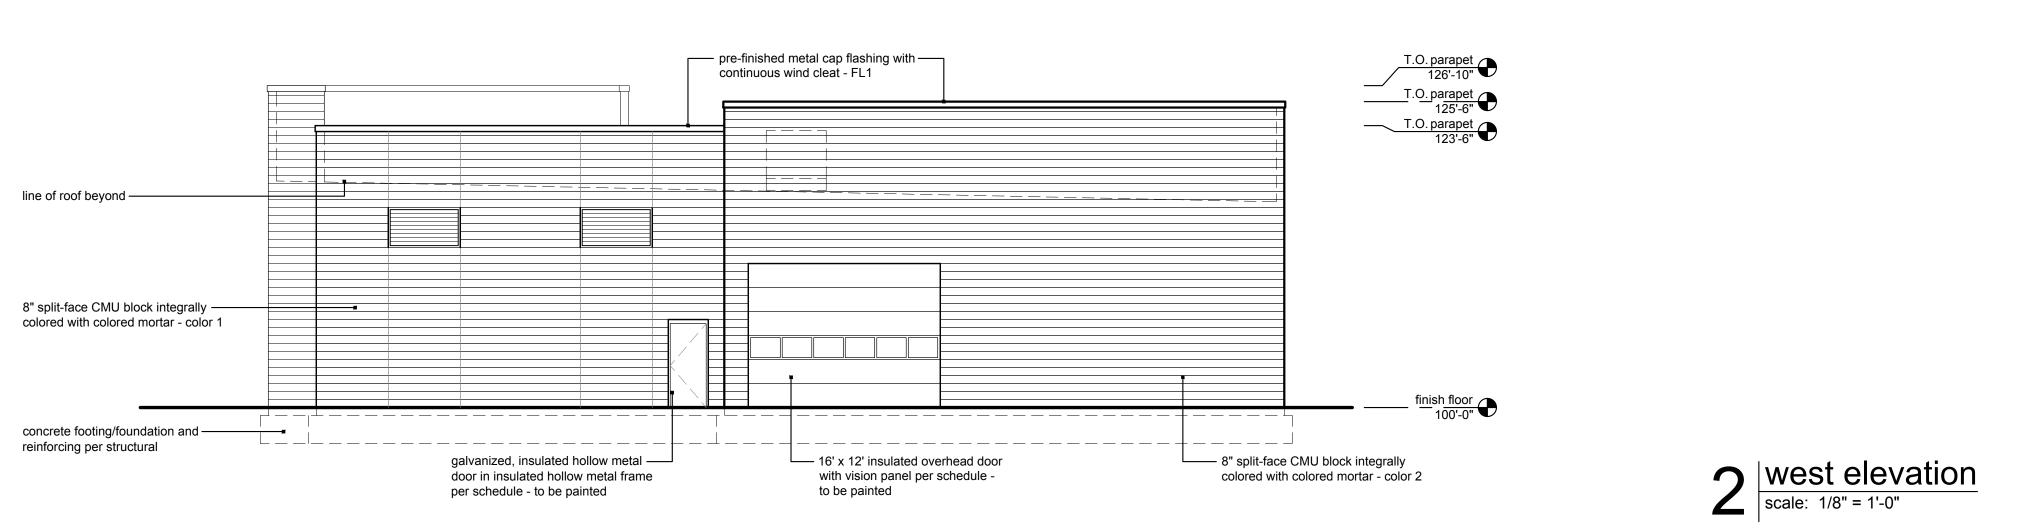
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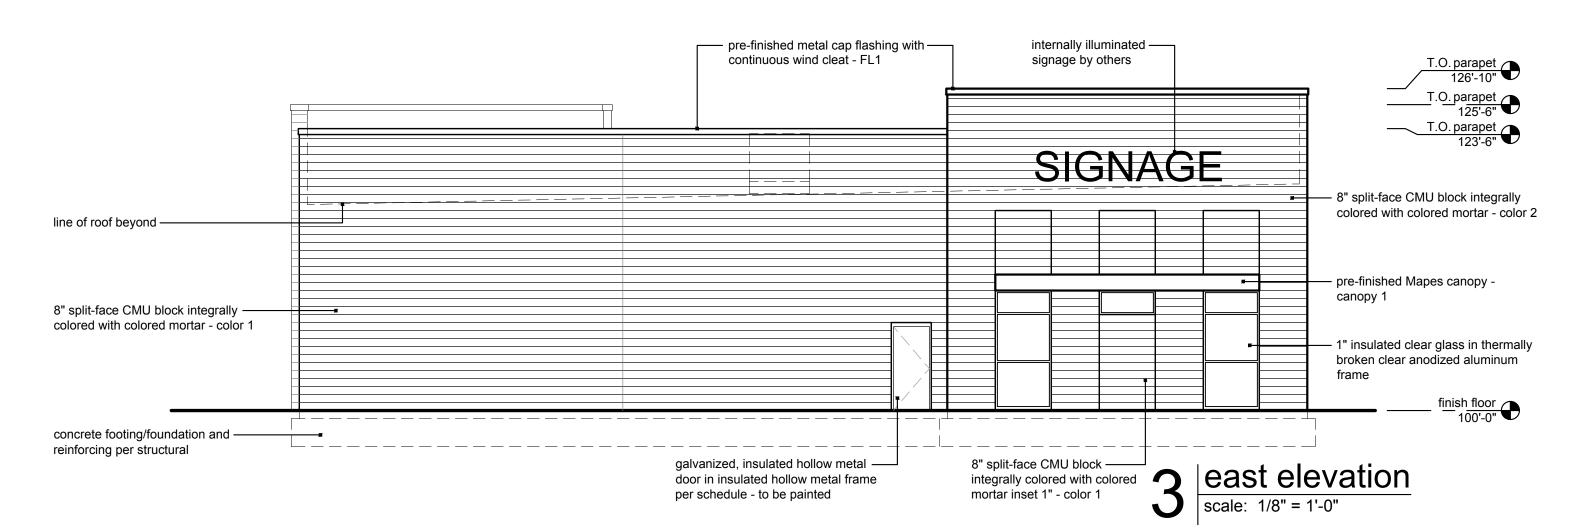
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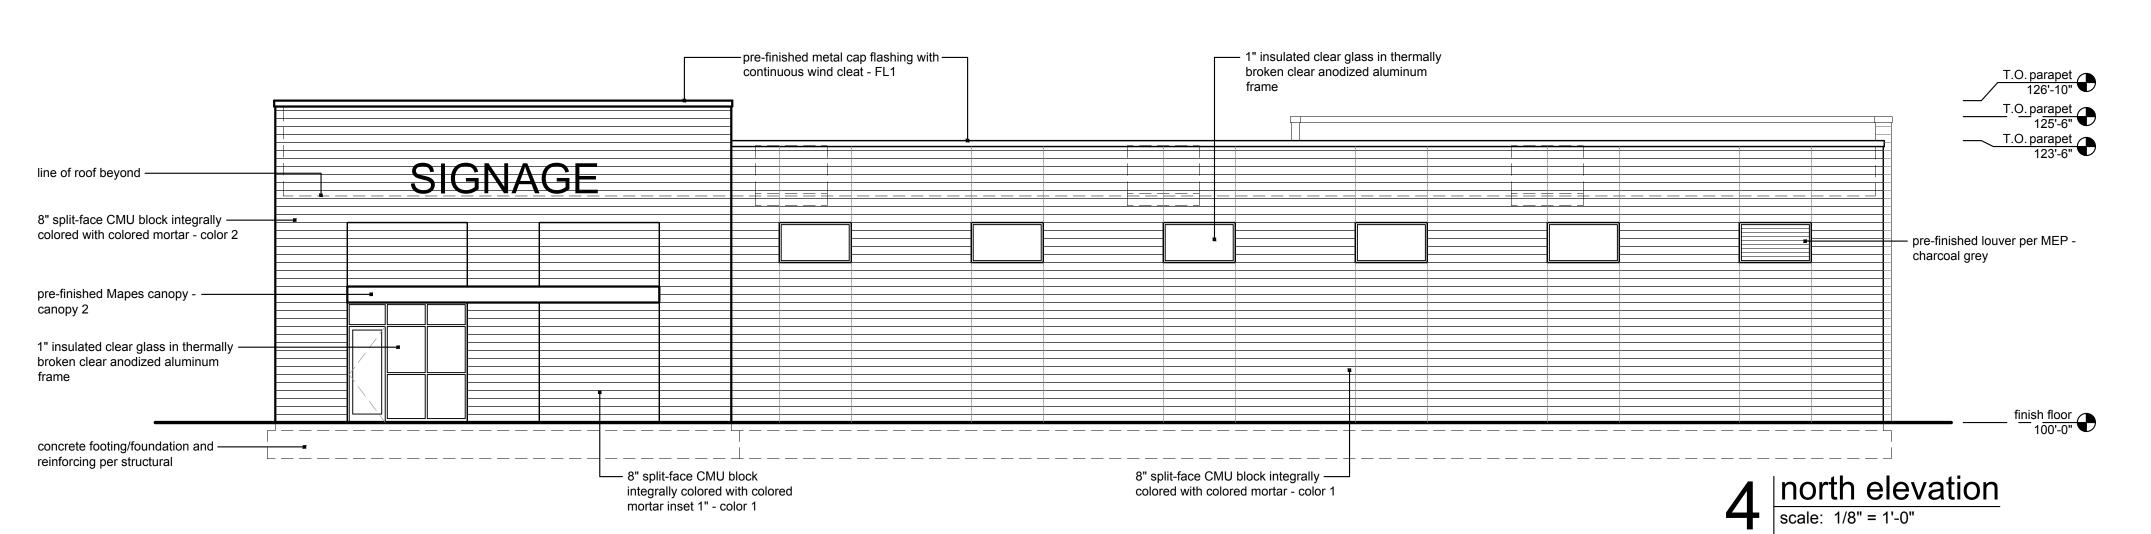
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plan for

date
04.03.2018
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sheet number

A3.1

drawing type
preliminary
project number
18014

### exterior materials and finishes:

CMU:

color 1 - Midwest Block & Brick, (split-face finish), color: limestone
color 2 - Midwest Block & Brick, (split-face finish), color: slate
\*all block shall include Dry-Block integral water repellant

integral color: tbd
\*all mortar shall include Dry-Block integral water repellant

Storefront:
anodized aluminum frame, color: clear

Glass:
1" insulated with low-E coating and argon fill
\*use SOLARBAN 60 as basis

Caulk: to match adjacent walls

Flashing: pre-finished 24 ga., Firestone, color: charcoal grey

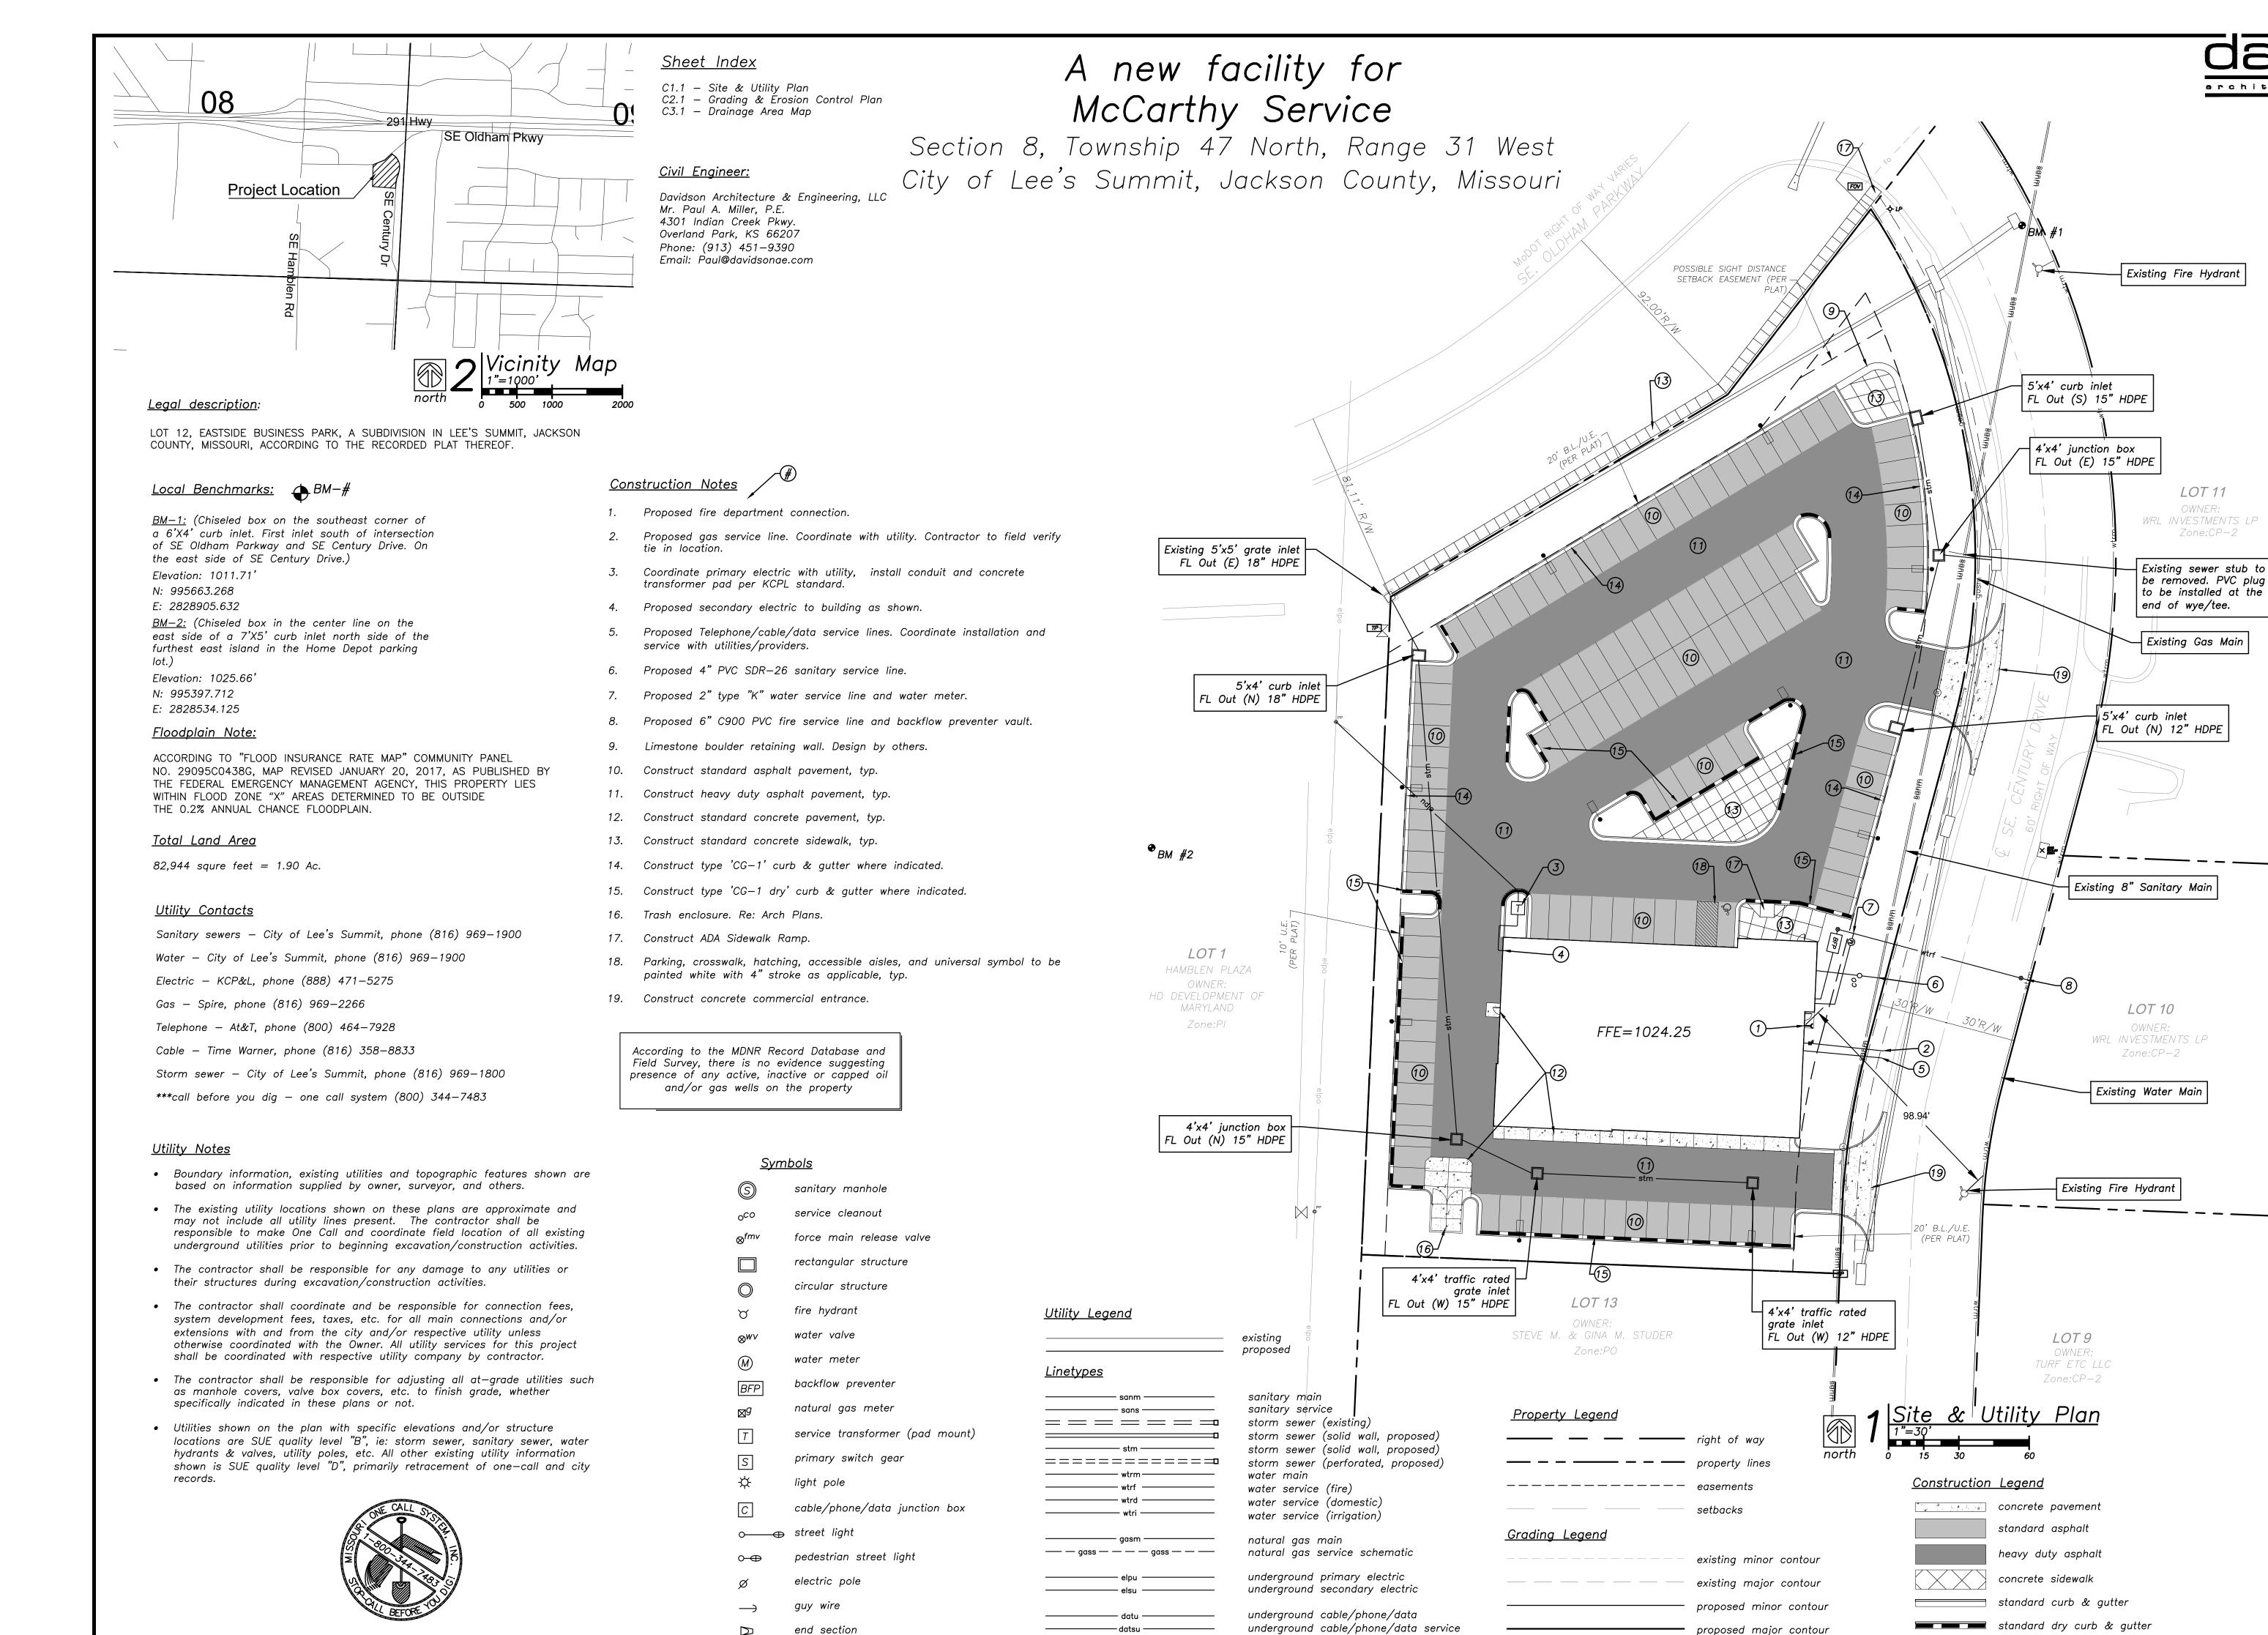
Canopy:
canopy 1 - Mapes, cantilever, supershade, color: GM Chevy blue
canopy 2 - Mapes, cantilever, lumishade, color: GM Chevy blue

Bollards: paint safety yellow

Hollow Metal Doors: Sherwin Williams, color: web grey SW7075

Overhead Doors:

Sherwin Williams, color: web grey SW7075



architecture & engineering

4301 Indian Creek Parkway


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Davidson Architecture
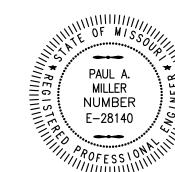
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