
PROJECT SCHEDULE				
	SIGN TYPE/ DESCRIPTION:	QTY.:	PG.	
c	W/ BACKGROUND PANEL ON WIREWAY (EYEMART)  W/ BACKGROUND PANEL ON WIREWAY (EYE EXAMS)  INTERNALLY ILLIH INNATED FACE LITERAN IN LETTEDS  WIREWAY (EYE EYAMS)			
D.	INTERNALLY ILLUMINATED FACE-LIT CHANNEL LETTERS W/ BACKGROUND PANEL ON WIREWAY (EYEMART)	ONE (1)	8	

PROJECT:

# **EYEMART**

WALMART SUPERCENTER 1041 NE SAM WALTON LANE LEE'S SUMMIT, MO 64086

REVISIONS				
#	DATE	DB	NOTES	
R1	11/10/2020	MAF	ADDED "EYE EXAMS" SIGN TO STOREFRONT; CHANGED SIDE "OPTOMETRIST" SIGN TO "EYE EXAMS".	
R2	1/12/2021	MAF	REDUCED SIZE OF BANNER TO UNDER 40SF.	
R3	1/13/2021	MAF	BACKGROUND PANELS & RETURNS NOW OFF- WHITE IN COLOR; RACEWAYS ARE NOW WIREWAYS.	
R4	1/29/2021	MAF	UPDATED W/ ACTUAL STORE/OFFICE HOURS; NEW DR. LOGO.	
R5	2/82021	MAF	ADDED PARKING SIGNAGE.	

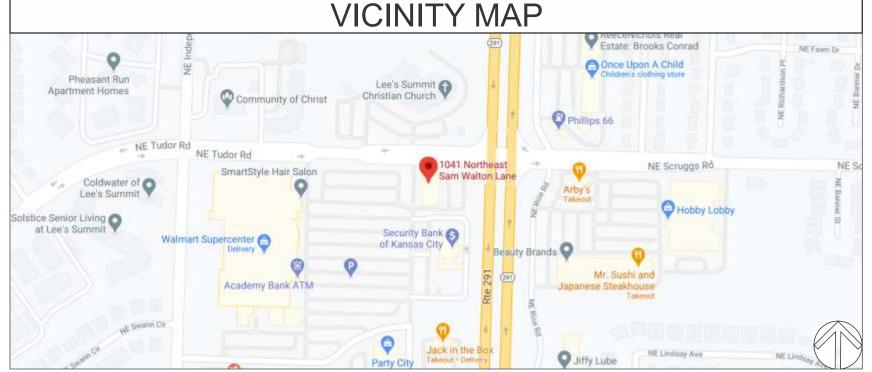



**CLIENT & LOCATION** 



WALMART SUPERCENTER 1041 NE SAM WALTON LANE LEE'S SUMMIT, MO 64086 LEAD NO. DATE REVIEWED BY 11/9/2020

SALESMAN DRAWN BY SEG. NO. S. ALTSHULER MAF

SHEET NO.

### **REAR ELEVATION - FACING WALMART SUPERCENTER**

SCALE: N.T.S





**CLIENT & LOCATION** 



WALMART SUPERCENTER 1041 NE SAM WALTON LANE LEE'S SUMMIT, MO 64086 LEAD NO.
195389 R5

SALESMAN
S. ALTSHULER

DATE
11/9/2020

REVIEWED BY
SEG. NO.
SEG. NO.

REVISION


SHEET NO.

D

#### INTERNALLY ILLUMINATED FACE-LIT CHANNEL LETTERS W/ BACKGROUND PANEL ON WIREWAY

SCALE: 1/2" = 1'-0"

QTY.: ONE (1)

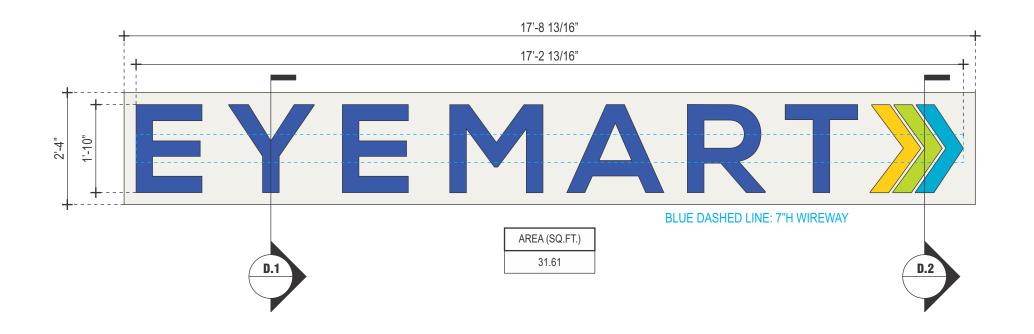





**CLIENT & LOCATION** 



WALMART SUPERCENTER 1041 NE SAM WALTON LANE LEE'S SUMMIT, MO 64086 LEAD NO. DATE REVIEWED BY
195389 R5 11/9/2020


SALESMAN DRAWN BY SEG. NO.
S. ALTSHULER MAF

REVISION

SHEET NO.

## A.1 B.1 C.1 D.1

SCALE: N.T.S.

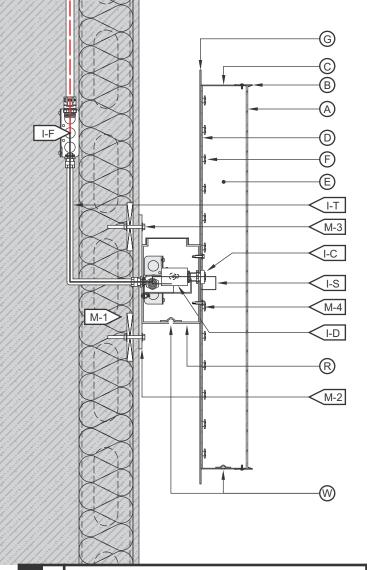

FACE-LIT CHAN	NEL LETTERS / LED ILLUMINATION / EXTERIOR INSTALL	. / WIREWAY MOUNTED / E	G PANEL
A FACE		(I) WIRING	
MATERIAL:	3/16" WHITE PLEX #2447.	I-C:	BUSHING
VINYL:	3M PERFORATED DAY/NIGHT EFFECT; 1ST SURFACE	I-D:	DISCONN
COLOR:	PAINT TO MATCH PMS 2935U	I-F:	SEE ELEC
B TRIMCAP		I-T:	14awg FE
SIZE / FINISH	1" / MATCH RETURNS.	I-J:	STANDAF
© RETURN		I-H:	W.P. BOX
DEPTH:	5".		LIQUID TI
MATERIAL:	0.040" ALUM.	I-S:	U.L. APPF
COLOR/ FINISH:	OFF-WHITE/ SATIN.		(ALL CON
D BACK	•	J POWER SUPPLY	•
MATERIAL:	3MM ACM.	TYPE:	LED POW
COLOR/ FINISH:	OFF-WHITE/ SATIN.	VOLTAGE:	120V.
E) INSIDE OF CAN	•	R WIREWAY	•
COLOR:	PRE-COAT WHITE.	MATERIAL:	7" x 4" AL
F) ILLUMINATION	•	COLOR/ FINISH:	PAINT TO
TYPE/COLOR:	LEDS/6500K WHITE	M MOUNTING	•
<b>G</b> BG PANEL	•	M-1:	SEE MOL
MATERIAL:	1/8" ALUMINUM	M-2:	MOUNTIN
COLOR/FINISH:	OFF-WHITE/SATIN	M-3:	3/8"Ø ALI
		M-4:	SELF-TAF
		W WEEP HOLE	
	OFF-WHITE PMS 2935U	TYPE:	1/4ӯ w/ 0
	- 1 ms 2000	-	

(I) WIRING	
I-C:	BUSHING.
I-D:	DISCONNECT SWITCH @ SIDE OF RACEWAY.
I-F:	SEE ELEC. NOTE. 120V PRIMARY IN J-BOX BY OTHERS.
I-T:	14awg FEED IN 1/2"Ø SEAL-TITE w/ 1/2" CONNECTORS.
I-J:	STANDARD JUNCTION BOX.
I-H:	W.P. BOX @ DISCONNECT SWITCH.
I-P:	LIQUID TIGHT CONNECTOR.
I-S:	U.L. APPROVED CLASS II LOW VOLTAGE WIRE.
	(ALL CONNECTIONS TO BE IN WATERPROOF BOXES).
J POWER SUPPLY	
TYPE:	LED POWER SUPPLY HOUSE IN RACEWAY.
VOLTAGE:	120V.
R WIREWAY	
MATERIAL:	7" x 4" ALUM. LED EXTRUSION RACEWAY, TOP ACCESS.
COLOR/ FINISH:	PAINT TO MATCH EXISTING FASCIA FINISH.
M MOUNTING	
M-1:	SEE MOUNTING NOTE. REQ'D. BLOCKING BY OTHERS.
M-2:	MOUNTING BARS 2"W. x 1/4" ALUM. w/ 3/4"Ø MNTG. HOLE.
M-3:	3/8"Ø ALLTHREAD, NUT & WASHERS INTO BLOCKING BEYON
M-4:	SELF-TAPPING SCREW.
W WEEP HOLE	
TYPE:	1/4"Ø w/ COVERS.

120V INSTALL

- CUSTOMER G.C. TO PROVIDE ADEQUATE WOOD OR MTL. BLOCKING IN CORRELATION W/ FACADE FRAMING AS REQUIRED.
- INSTALLER IS TO V.I.F. & PROVIDE THE PROPER NON-CORROSIVE MOUNTING HARDWARE TO ENSURE SAFE INSTALLATION.
- 3. ALL EXTERIOR FACADE PENETRATIONS TO BE WATERTIGHT.
- INSTALLATION TO MEET CURRENT N.E.C., U.L. & LOCAL CODES.
   LOCATION OF THE DISCONNECT SWITCH AFTER INSTALLATION SHALL
   COMPLY WITH ARTICLE 600.6(A) (1) OF THE NATION ELECTRICAL CODE
- 1. ALL ELECTRICAL COMPONENTS TO BE U.L. APPROVED.
- CUSTOMER IS RESPONSIBLE FOR ONE (1) 120v/ 20a DEDICATED CIRCUIT w/ GROUND PER SIGN TO WITHIN 6' OF SIGN.
- 3. THIS SIGN IS INTENDED TO BE INSTALLED IN ACCORDING W/ THE REQUIREMENTS OF ARTICLE 600 OF THE NATIONAL ELECTRICAL CODE AND/OR OTHER APPLICABLE LOCAL CODES. THIS INCLUDES PROPER GROUNDING & BONDING OF THE SIGN.

FABRICATOR

- PLACEMENT OF LIGHTING ELEMENTS FOR OPTIMUM ILLUMINATION OF SIGN TO BE DETERMINED IN PRODUCTION.
- MANUFACTURER & U.L. LABELS TO BE APPLIED & VISIBLE FROM THE GROUND. LOCATED ON THE LAST CHANNEL LETTER OR END OF THE SIGN BOX/FREESTANDING SIGN





**CLIENT & LOCATION** 




ELECTRICAL

WALMART SUPERCENTER 1041 NE SAM WALTON LANE LEE'S SUMMIT, MO 64086

LEAD NO.	DATE	REVIEWED BY	REVISION
195389 R5	11/9/2020		
SALESMAN	DRAWN BY	SEG. NO.	
S. ALTSHULER	MAF		

SHEET NO.

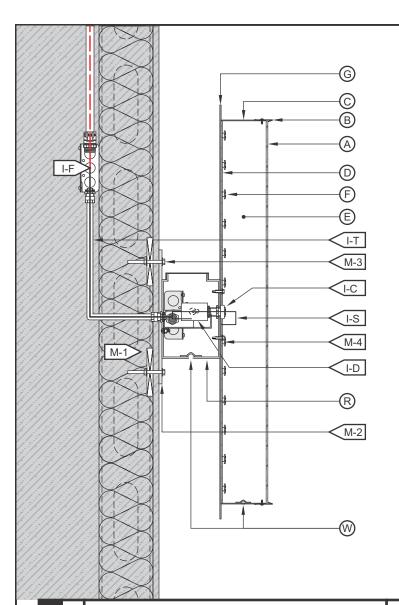



A.2 D.2

#### "LOGO" FACE-LIT CHANNEL LETTER / LED ILLUMINATION / EXTERIOR INSTALL / WIREWAY MOUNTED / BG PANEL

SCALE: N.T.S.

A) FACE	
MATERIAL:	3/16" WHITE PLEX #2447.
VINYL:	TRANSLUCENT
COLOR:	PRINT TO MATCH PMS 2935U, 115U, 312U & 381U
B TRIMCAP	•
SIZE / FINISH	1" / MATCH RETURNS.
C RETURN	
DEPTH:	5".
MATERIAL:	0.040" ALUM.
COLOR/ FINISH:	OFF-WHITE/ SATIN.
D BACK	
MATERIAL:	3MM ACM.
COLOR/ FINISH:	OFF-WHITE/ SATIN.
E) INSIDE OF CAN	
COLOR:	PRE-COAT WHITE.
F) ILLUMINATION	
TYPE/COLOR:	LEDS/6500K WHITE
<b>G</b> ) BG PANEL	
MATERIAL:	1/8" ALUMINUM
COLOR/FINISH:	OFF-WHITE/SATIN

(I) WIRING	
I-C:	BUSHING.
I-D:	DISCONNECT SWITCH @ SIDE OF RACEWAY.
I-F:	SEE ELEC. NOTE. 120V PRIMARY IN J-BOX BY OTHERS.
I-T:	14awg FEED IN 1/2"Ø SEAL-TITE w/ 1/2" CONNECTORS.
I-J:	STANDARD JUNCTION BOX.
I-H:	W.P. BOX @ DISCONNECT SWITCH.
I-P:	LIQUID TIGHT CONNECTOR.
I-S:	U.L. APPROVED CLASS II LOW VOLTAGE WIRE.
	(ALL CONNECTIONS TO BE IN WATERPROOF BOXES).
J POWER SUPPLY	
TYPE:	LED POWER SUPPLY HOUSE IN RACEWAY.
VOLTAGE:	120V.
R WIREWAY	
MATERIAL:	7" x 4" ALUMINUM EXTRUSION, TOP ACCESS.
COLOR/ FINISH:	MATCH FASCIA.
M MOUNTING	
M-1:	SEE MOUNTING NOTE. REQ'D. BLOCKING BY OTHERS.
M-2:	MOUNTING BARS 2"W. x 1/4" ALUM. w/ 3/4"Ø MNTG. HOLE.
M-3:	3/8"Ø ALLTHREAD, NUT & WASHERS INTO BLOCKING BEYONE
M-4:	SELF-TAPPING SCREW.
W WEEP HOLE	
TYPE:	1/4"Ø w/ COVERS.

120V INSTALL

- 1. CUSTOMER G.C. TO PROVIDE ADEQUATE WOOD OR MTL. BLOCKING IN CORRELATION W/ FACADE FRAMING AS REQUIRED.
- 2. INSTALLER IS TO V.I.F. & PROVIDE THE PROPER NON-CORROSIVE MOUNTING HARDWARE TO ENSURE SAFE INSTALLATION.
- 3. ALL EXTERIOR FACADE PENETRATIONS TO BE WATERTIGHT.
- INSTALLATION TO MEET CURRENT N.E.C., U.L. & LOCAL CODES. LOCATION OF THE DISCONNECT SWITCH AFTER INSTALLATION SHALL COMPLY WITH ARTICLE 600.6(A) (1) OF THE NATION ELECTRICAL CODE
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- PLACEMENT OF LIGHTING ELEMENTS FOR OPTIMUM ILLUMINATION
   OF SIGN TO BE DETERMINED IN PRODUCTION.
- MANUFACTURER & U.L. LABELS TO BE APPLIED & VISIBLE FROM THE GROUND. LOCATED ON THE LAST CHANNEL LETTER OR END OF THE SIGN BOX/FREESTANDING SIGN



ALL ELECTRICAL COMPONENTS ARE TO BE UL APPROVED



**CLIENT & LOCATION** 



ELECTRICAL

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